


# GOLD CAMP SHOOTING SPORTS CENTER

## Special Use Development Plan

### Sheet Key:

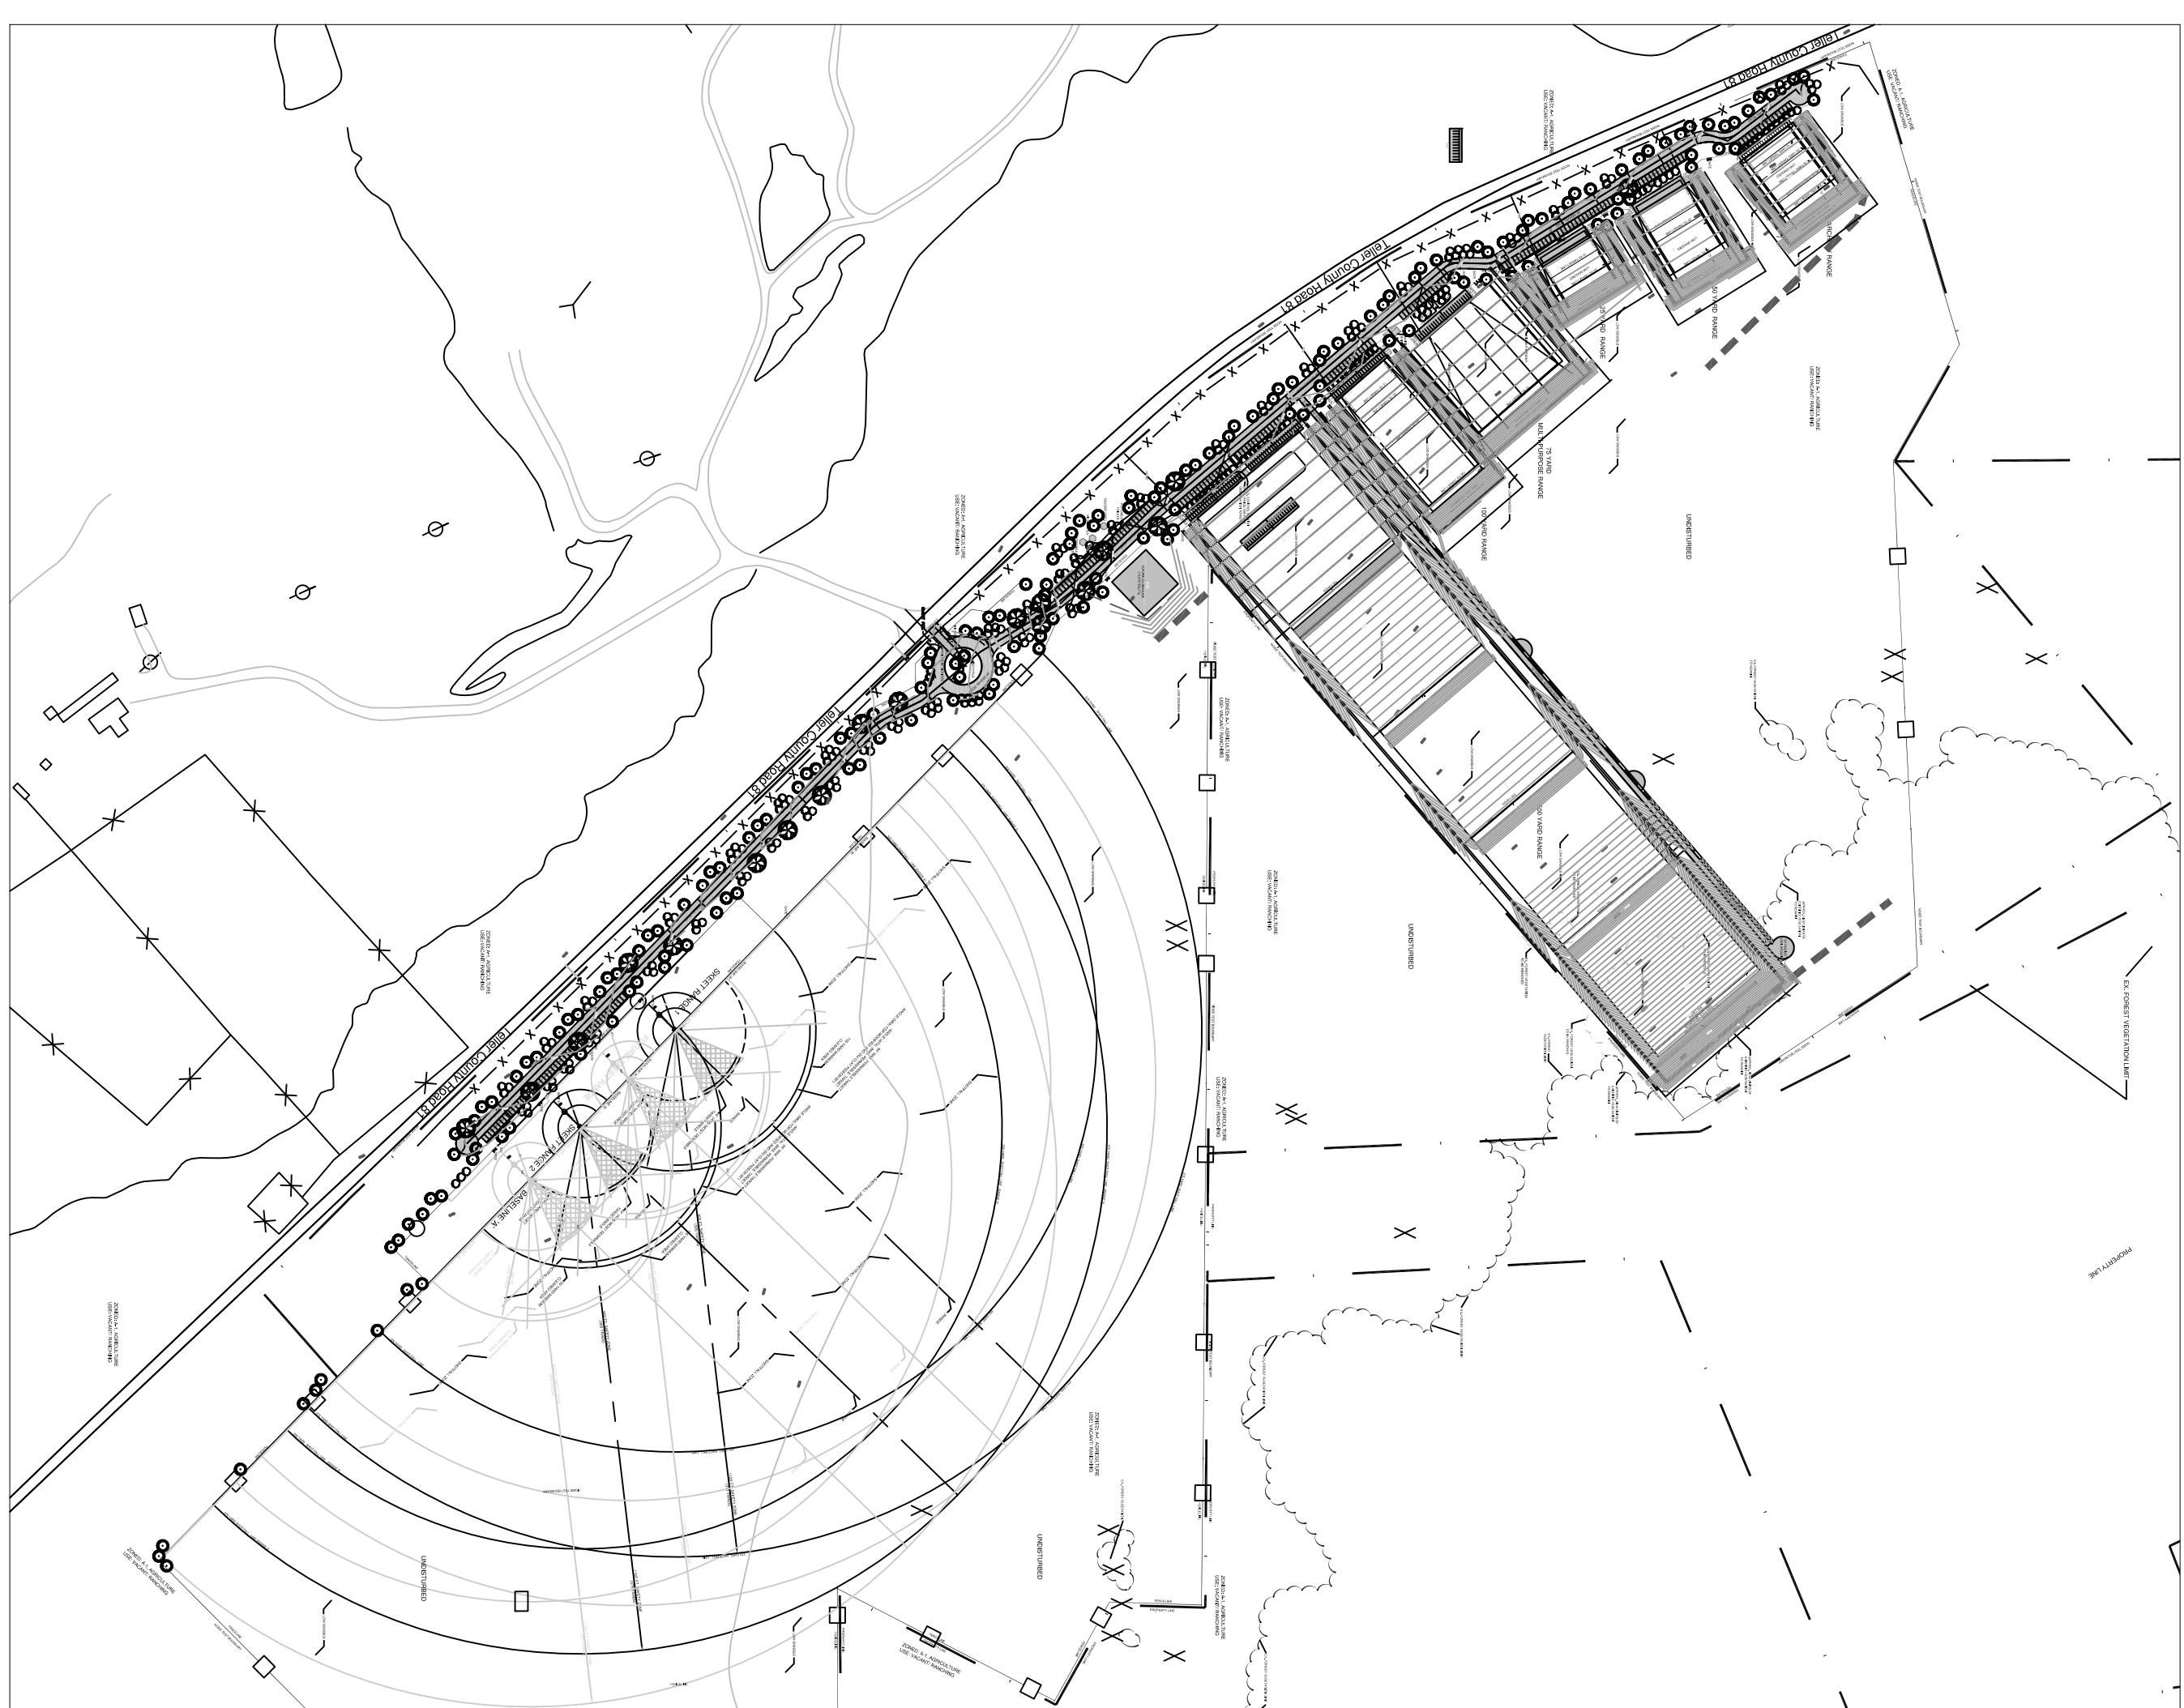

### Gold Camp Shooting Sports Center County Road 81

TELLER COUNTY, CO



### Applicability

The provisions of this SU shall run with the land. The landowners, their successors, heirs, or assigns shall be bound by this Development Plan, as amended and approved by the Teller County Planning Department.

### Addition

The addition of this development plan shall evidence the findings and decisions of the Teller County Board of County Commissioners that this Development Plan or Teller County Shooting Society is in general conformity with the Teller County Master Plan, Teller County Soil Conservation Plan and applicable Small Area Plans; is authorized under the provision of the Teller Land Development Code, and the Teller County Land Development Code.

### Relationship to County Regulations

The provisions of this Development Plan shall prevail and govern the development of the Gold Camp Shooting Sports Center, provided, however, that where the provisions of this Development Plan do not address a particular subject, the relevant provisions of the Teller County Land Development Code, as amended and in effect at the time of the SU plan approval (or owner acknowledge the SU changes with the Code), or any other applicable resolutions or regulations of Teller County, shall be applicable.

### Enforcement

To further the mutual interest of the residents, occupants, and owners of the SU and of the public in the preservation of the integrity of this development plan, the provisions of this plan relating to the use of land and the location of common open space shall run in favor of Teller County and shall be enforceable at law or in equity by the County without limitation on any power or regulation otherwise granted by law.

### Conflict

Where there is more than one provision within the development plan that covers the same subject matter, the provision which is most restrictive or imposes higher standards or requirements shall govern.

### Overall Project Standard

The Standard Zoning regulations of the Teller County Land Development Code including off-street parking, landscaping, site development, accessory and temporary uses, and use by special review and variance processes shall apply to this SU, except as modified by the SU.

### GENERAL NOTES

1. There is no proposed plating plan for Gold Camp Shooting Sports Center. The development scheduling and build-out will be based upon Teller County Shooting Society (TCSS) membership enrollment and economic conditions. Development trends may overlap one another allowing constant and continuous growth of the site as membership trends dictate. Site improvements will be provided as needed for development.
2. Development of this property shall be in accordance with this Special Use Development Plan. Modifications are subject to review and approval by the Teller County Board of County Commissioners unless otherwise provided by the Teller County Land Development Code.
3. Central Water and Waste Water services are not required and not will be provided under this Special Use Development Plan.
4. Electricity will not be provided to the site.
5. Port-a-Potty or temporary and movable bathroom facilities will be provided by the Gold Camp Shooting Sports Center.
6. All Tracts to be owned or temporary or movable bathroom facilities will be provided by the Gold Camp Shooting Sports Center.
7. First shooting range placement to be determined in the field based on grade, vegetation, and other existing site features.
8. No site lighting is proposed or will be provided; operating hours are during daylight hours only.
9. The site will be locked at all times, except for public events, and access is limited to members of the Teller County Shooting Society/ Gold Camp Shooting Sports Center.

### LANDSCAPING, PARKING, NOISE, AND TRAFFIC NOTES

EXISTING ZONING: A-1 AGRICULTURE  
PROPOSED ZONING: A-1 SPECIAL USE  
TOTAL GROSS AREA: 142.7 +/- Acres


### DEVELOPMENT DATA

TOTAL SITE ACREAGE				
TYPE OF USE	# ACRES	% OF PROPERTY	REQUIRED	PROVIDED
RIGHTS-OF-WAY				
OPEN SPACE (ALL USES)				
TOTAL				

### Legal Description:

A PORTION OF SECTIONS 9 AND 10, TOWNSHIP 15 SOUTH, RANGE 69 WEST OF THE 6TH P.M., IN TELLER COUNTY, COLORADO.

BEGINNING AT A POINT ON THE EASTERN RIGHT-OF-WAY OF COUNTY ROAD 81; THENCE ALONG SAID RIGHT-OF-WAY LINE, IN TELLER COUNTY, COLORADO, FOLLOWING EIGHT (8) COURSES; (1) S23°21'40" E FOR A DISTANCE OF 919.90 FEET; (2) ON A CURVE TO THE LEFT WITH A RADIUS OF 181.48 FEET, ANGLE OF 11°29'06" FOR A LENGTH OF 279.03 FEET; (3) S34°50'46" E FOR A DISTANCE OF 398.86 FEET; (4) S41°09'51" E FOR A DISTANCE OF 298.32 FEET; (5) S42°58'11" E FOR A DISTANCE OF 775.26 FEET; (6) S44°11'38" E FOR A DISTANCE OF 1095.78 FEET; (7) S45°22'35" E FOR A DISTANCE OF 831.77 FEET; THENCE N45°11'16" E FOR A DISTANCE OF 726.89 FEET; (8) N00°07'28"E FOR A DISTANCE OF 1,280.05 FEET TO A POINT ON THE NORTH LINE OF EL PASO PLACE; (9) N00°07'28"E FOR A DISTANCE OF 192.54 FEET TO THE NORTH LINE OF THE ROTHBERG AND LOSLEY PLACERS; BEING U.S. MINERAL SURVEY NO. 1144; THENCE ALONG SAID LINE N00°13'33"E FOR A DISTANCE OF 135.13 FEET; (10) N00°13'33"E FOR A DISTANCE OF 135.13 FEET TO THE NORTH LINE OF THE ROTHBERG AND LOSLEY PLACERS; BEING U.S. MINERAL SURVEY NO. 1144; THENCE ALONG SAID LINE N00°13'33"E FOR A DISTANCE OF 135.13 FEET; (11) N00°13'33"E FOR A DISTANCE OF 135.13 FEET TO THE NORTH LINE OF THE ROTHBERG AND LOSLEY PLACERS; BEING U.S. MINERAL SURVEY NO. 1144; THENCE ALONG SAID LINE N00°13'33"E FOR A DISTANCE OF 135.13 FEET; (12) N00°13'33"E FOR A DISTANCE OF 135.13 FEET TO THE NORTH LINE OF THE ROTHBERG AND LOSLEY PLACERS; BEING U.S. MINERAL SURVEY NO. 1144; THENCE ALONG SAID LINE N00°13'33"E FOR A DISTANCE OF 135.13 FEET; (13) N00°13'33"E FOR A DISTANCE OF 135.13 FEET TO THE NORTH LINE OF THE ROTHBERG AND LOSLEY PLACERS; BEING U.S. MINERAL SURVEY NO. 1144; THENCE ALONG SAID LINE N00°13'33"E FOR A DISTANCE OF 135.13 FEET; (14) N00°13'33"E FOR A DISTANCE OF 135.13 FEET TO THE NORTH LINE OF THE ROTHBERG AND LOSLEY PLACERS; BEING U.S. MINERAL SURVEY NO. 1144; THENCE ALONG SAID LINE N00°13'33"E FOR A DISTANCE OF 135.13 FEET; (15) N00°13'33"E FOR A DISTANCE OF 135.13 FEET TO THE NORTH LINE OF THE ROTHBERG AND LOSLEY PLACERS; BEING U.S. MINERAL SURVEY NO. 1144; THENCE ALONG SAID LINE N00°13'33"E FOR A DISTANCE OF 135.13 FEET; (16) N00°13'33"E FOR A DISTANCE OF 135.13 FEET TO THE NORTH LINE OF THE ROTHBERG AND LOSLEY PLACERS; BEING U.S. MINERAL SURVEY NO. 1144; THENCE ALONG SAID LINE N00°13'33"E FOR A DISTANCE OF 135.13 FEET; (17) N00°13'33"E FOR A DISTANCE OF 135.13 FEET TO THE NORTH LINE OF THE ROTHBERG AND LOSLEY PLACERS; BEING U.S. MINERAL SURVEY NO. 1144; THENCE ALONG SAID LINE N00°13'33"E FOR A DISTANCE OF 135.13 FEET; (18) N00°13'33"E FOR A DISTANCE OF 135.13 FEET TO THE NORTH LINE OF THE ROTHBERG AND LOSLEY PLACERS; BEING U.S. MINERAL SURVEY NO. 1144; THENCE ALONG SAID LINE N00°13'33"E FOR A DISTANCE OF 135.13 FEET; (19) N00°13'33"E FOR A DISTANCE OF 135.13 FEET TO THE NORTH LINE OF THE ROTHBERG AND LOSLEY PLACERS; BEING U.S. MINERAL SURVEY NO. 1144; THENCE ALONG SAID LINE N00°13'33"E FOR A DISTANCE OF 135.13 FEET; (20) N00°13'33"E FOR A DISTANCE OF 135.13 FEET TO THE NORTH LINE OF THE ROTHBERG AND LOSLEY PLACERS; 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BEING U.S. MINERAL SURVEY NO. 1144; THENCE ALONG SAID LINE N00°13'33"E FOR A DISTANCE OF 135.13 FEET; (51) N00°13'33"E FOR A DISTANCE OF 135.13 FEET TO THE NORTH LINE OF THE ROTHBERG AND LOSLEY PLACERS; BEING U.S. MINERAL SURVEY NO. 1144; THENCE ALONG SAID LINE N00°13'33"E FOR A DISTANCE OF 135.13 FEET; (52) N00°13'33"E FOR A DISTANCE OF 135.13 FEET TO THE NORTH LINE OF THE ROTHBERG AND LOSLEY PLACERS; BEING U.S. MINERAL SURVEY NO. 1144; THENCE ALONG SAID LINE N00°13'33"E FOR A DISTANCE OF 135.13 FEET; (53) N00°13'33"E FOR A DISTANCE OF 135.13 FEET TO THE NORTH LINE OF THE ROTHBERG AND LOSLEY PLACERS; BEING U.S. MINERAL SURVEY NO. 1144; THENCE ALONG SAID LINE N00°13'33"E FOR A DISTANCE OF 135.13 FEET; (54) N00°13'33"E FOR A DISTANCE OF 135.13 FEET TO THE NORTH LINE OF THE ROTHBERG AND LOSLEY PLACERS; BEING U.S. MINERAL SURVEY NO. 1144; THENCE ALONG SAID LINE N00°13'33"E FOR A DISTANCE OF 135.13 FEET; (55) N00°13'33"E FOR A DISTANCE OF 135.13 FEET TO THE NORTH LINE OF THE ROTHBERG AND LOSLEY PLACERS; 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BEING U.S. MINERAL SURVEY NO. 1144; THENCE ALONG SAID LINE N00°13'33"E FOR A DISTANCE OF 135.13 FEET; (61) N00°13'33"E FOR A DISTANCE OF 135.13 FEET TO THE NORTH LINE OF THE ROTHBERG AND LOSLEY PLACERS; BEING U.S. MINERAL SURVEY NO. 1144; THENCE ALONG SAID LINE N00°13'33"E FOR A DISTANCE OF 135.13 FEET; (62) N00

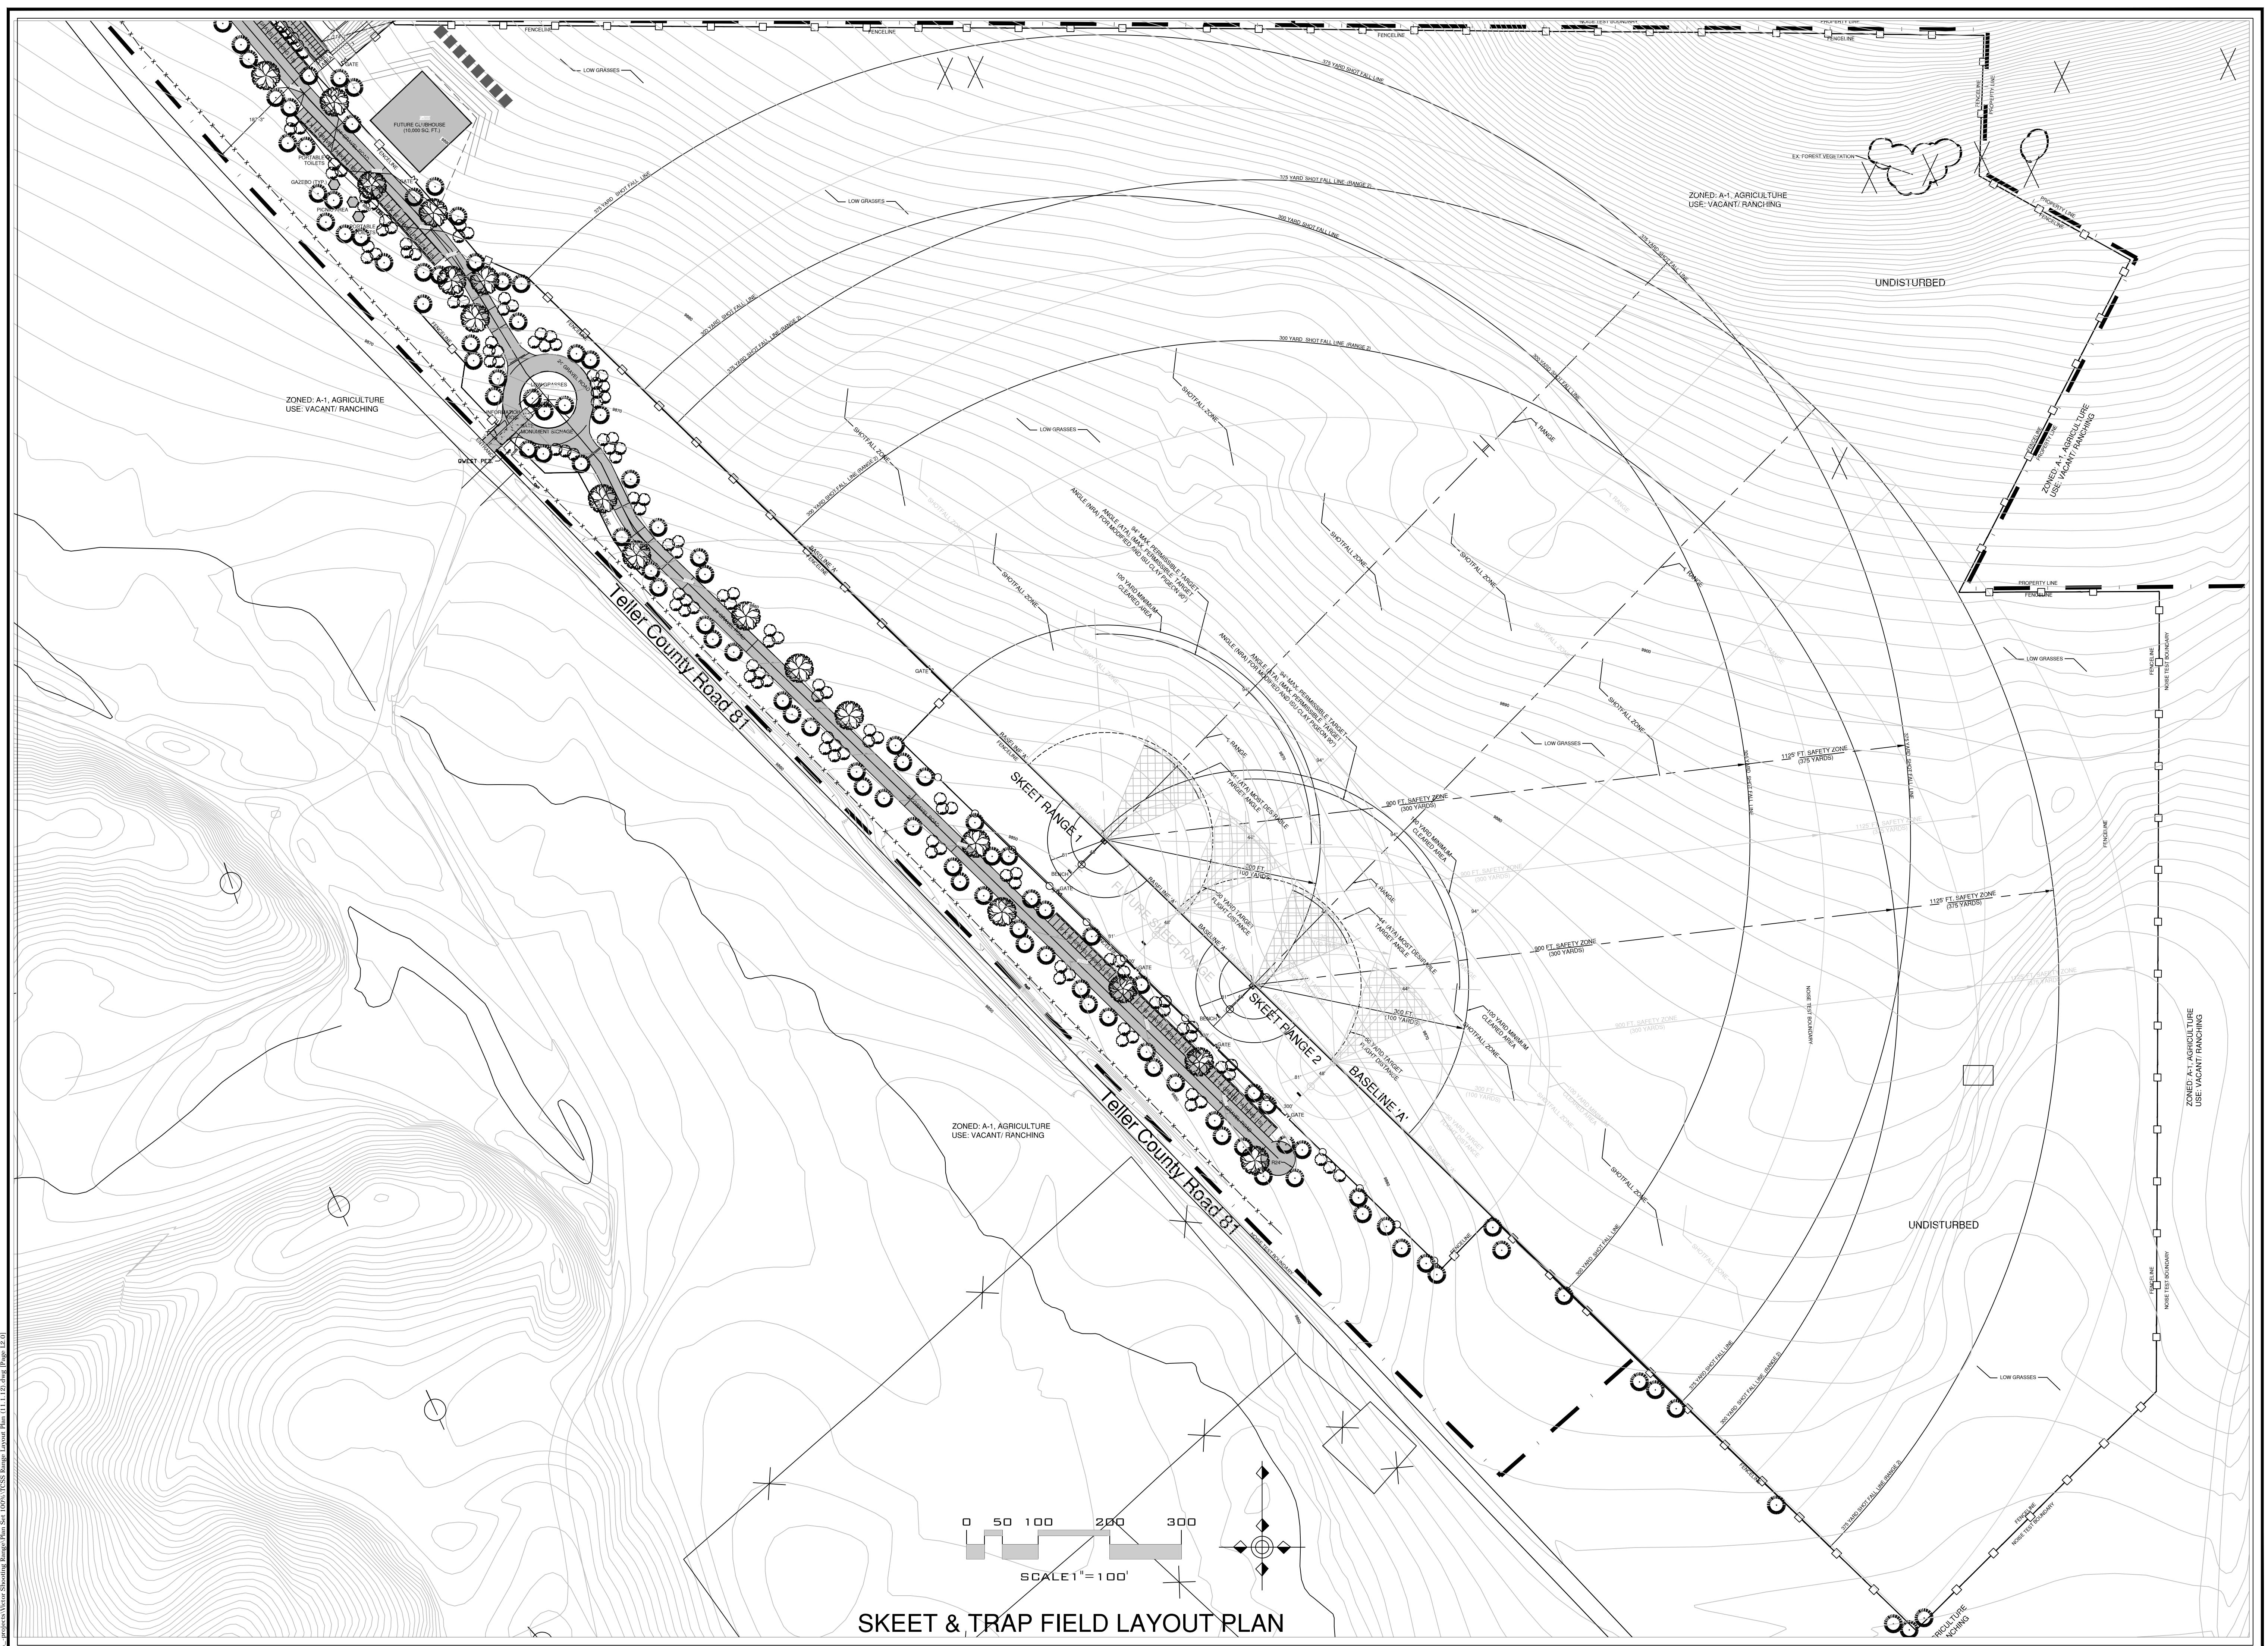

Gold Camp Shooting Sports Center  
County Road 81

DATE: 11/5/2012  
DRAWN: WFG  
CHECKED: JBA

**REVISIONS**

# SKEET & TRAP FIELD PLAN

SHEET NO. 2

OF - SHEETS

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Page 1 of 1

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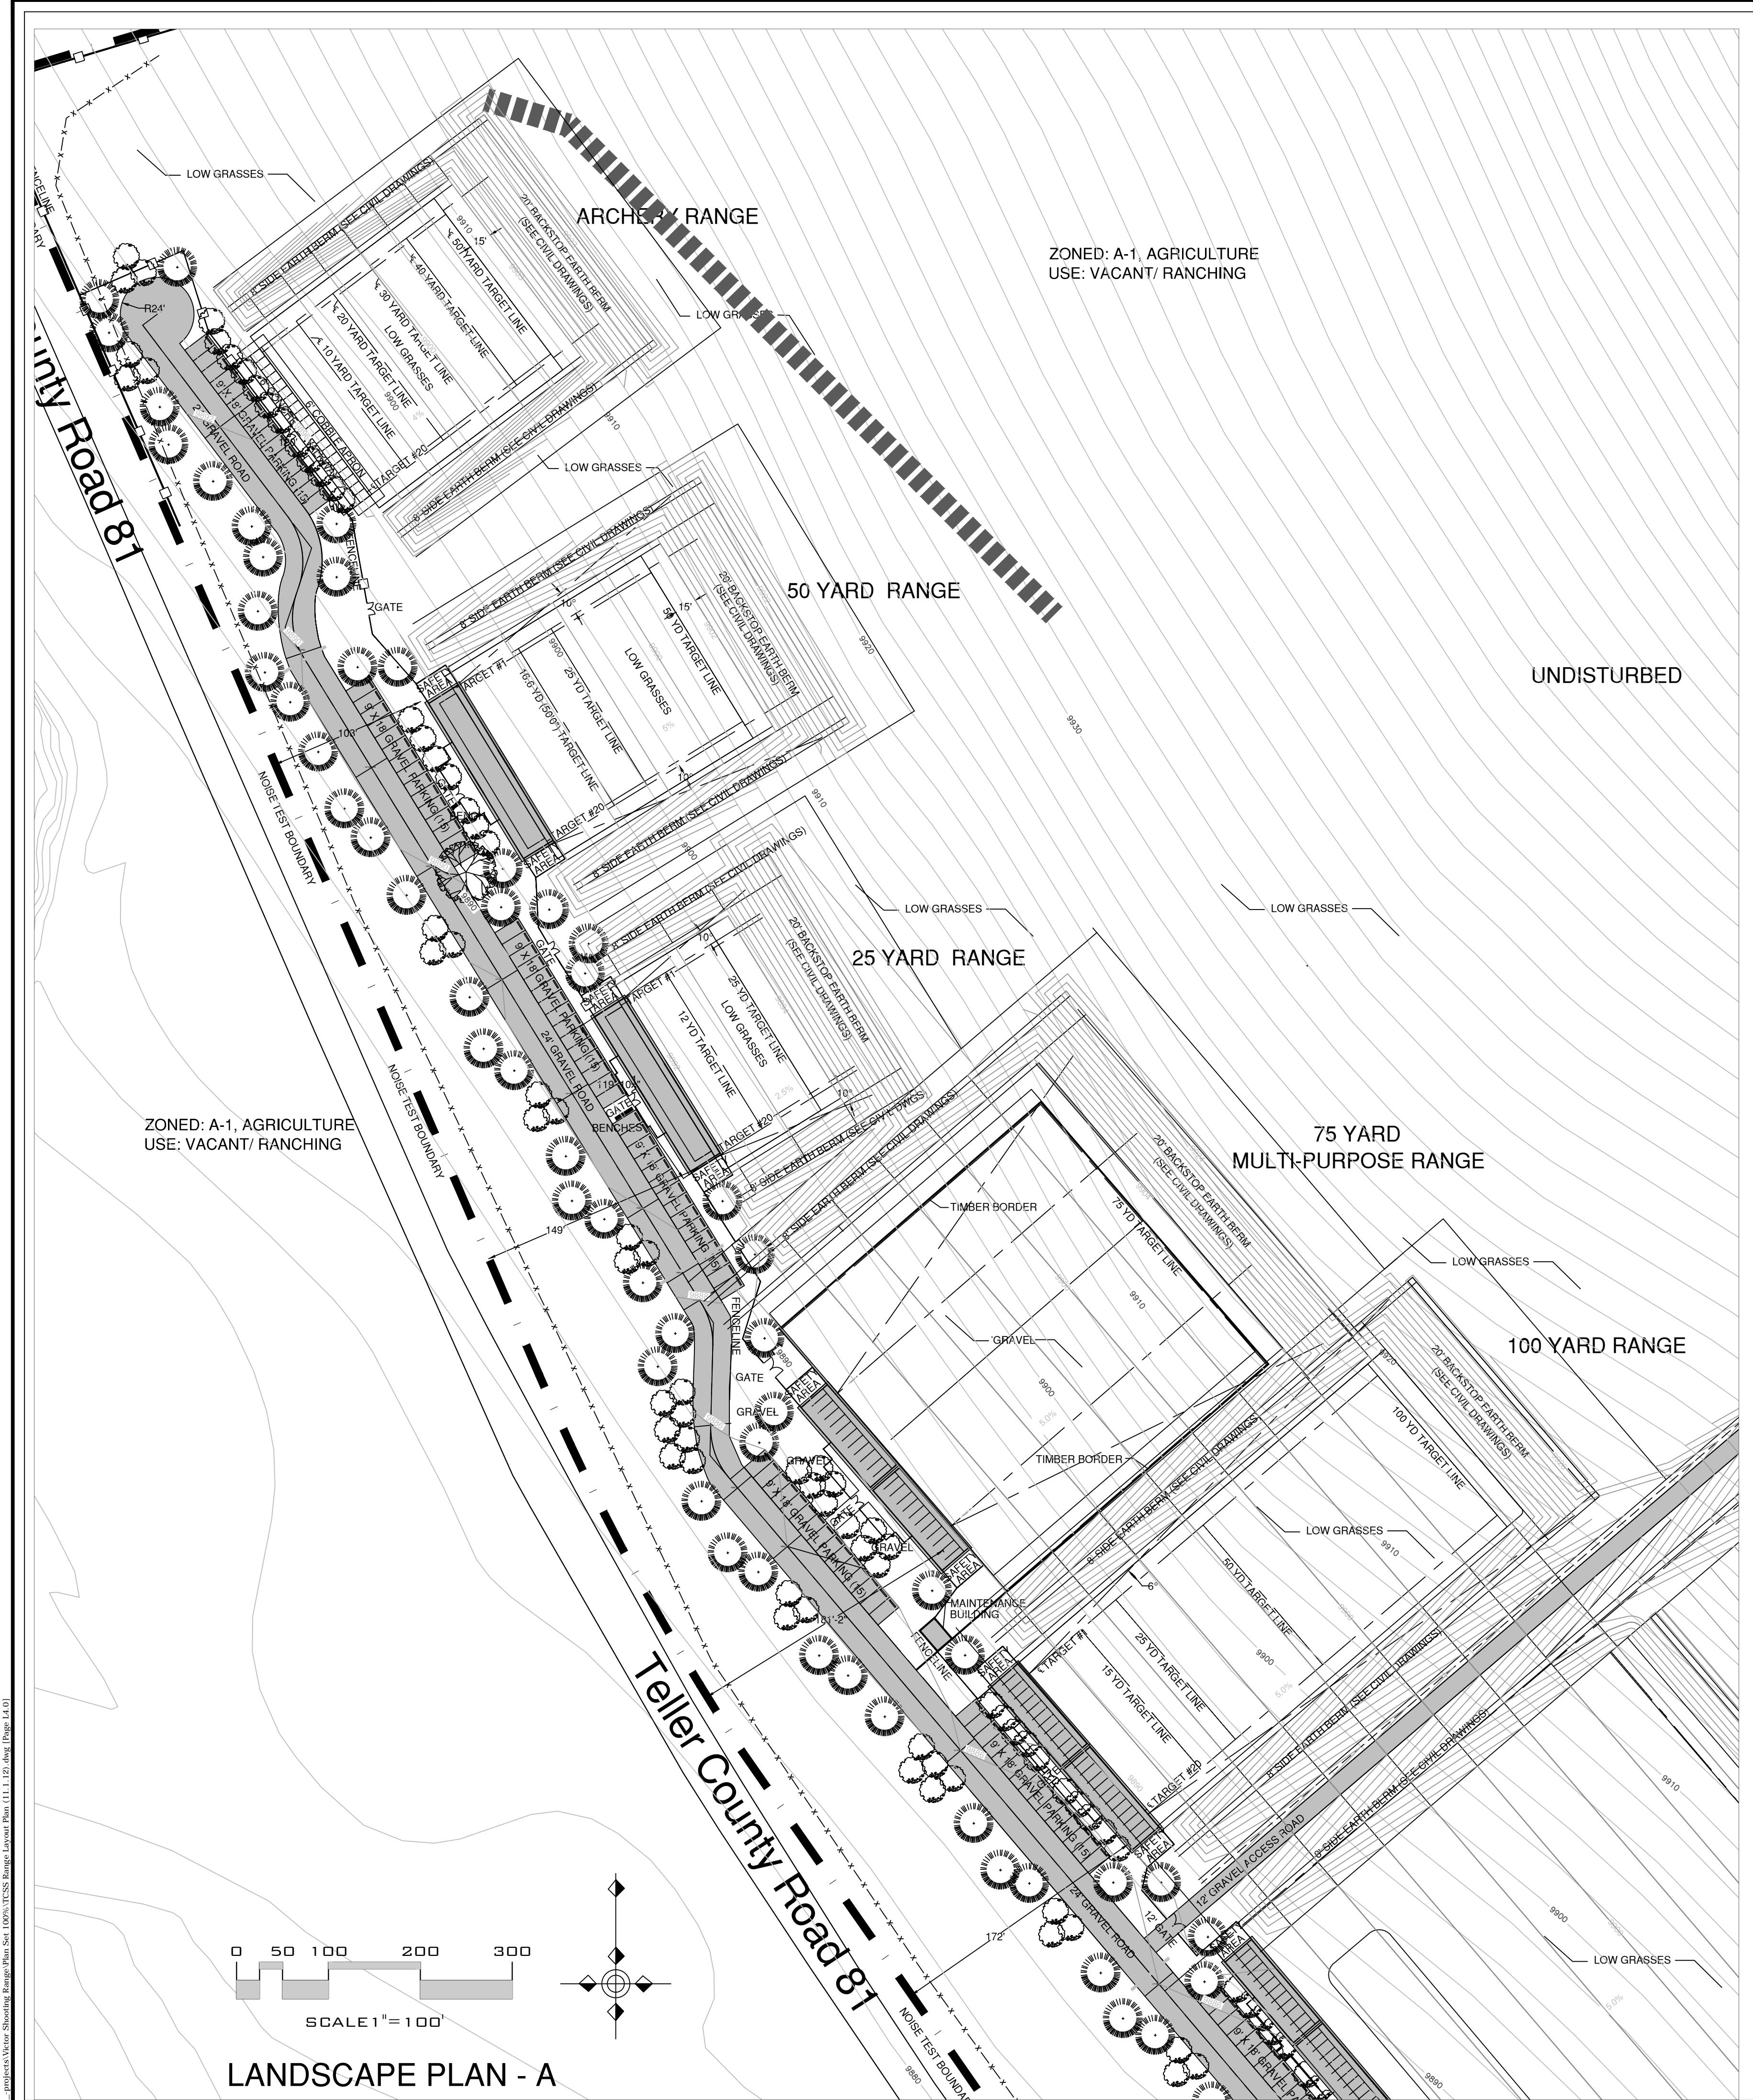
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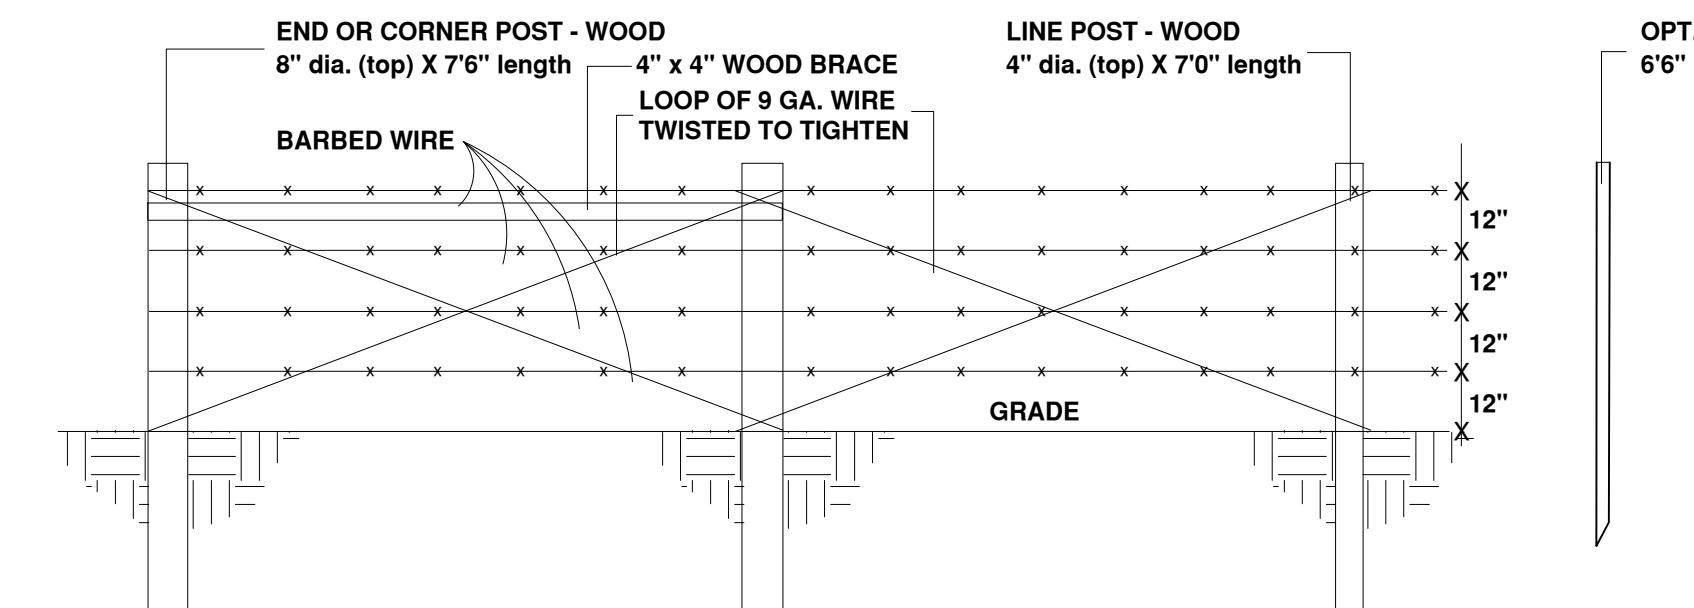
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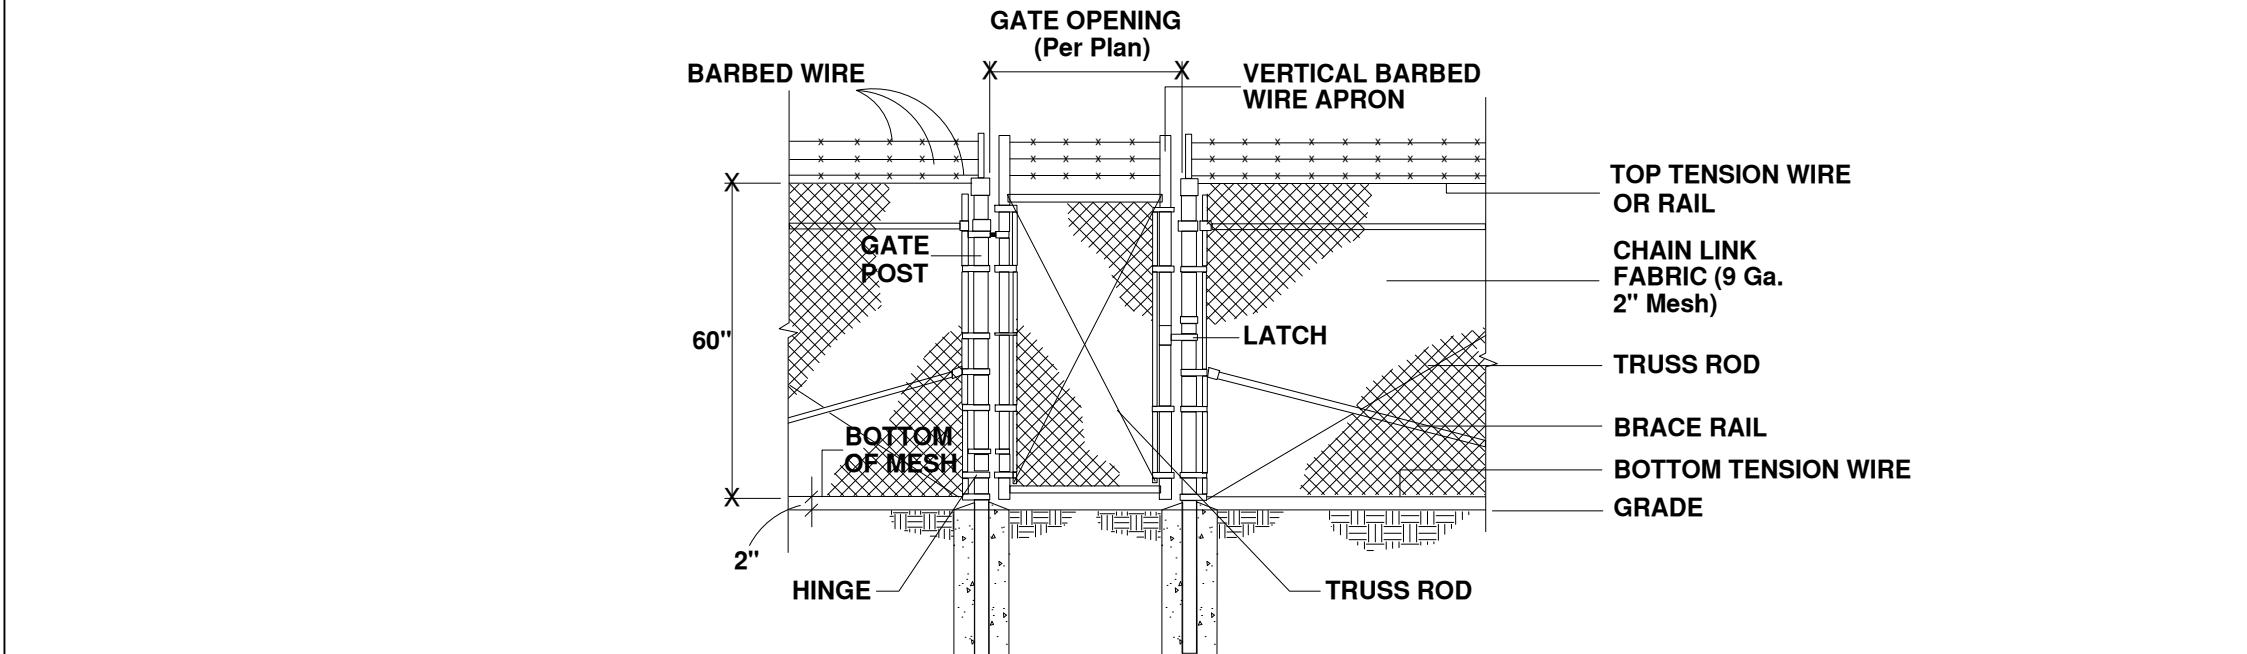
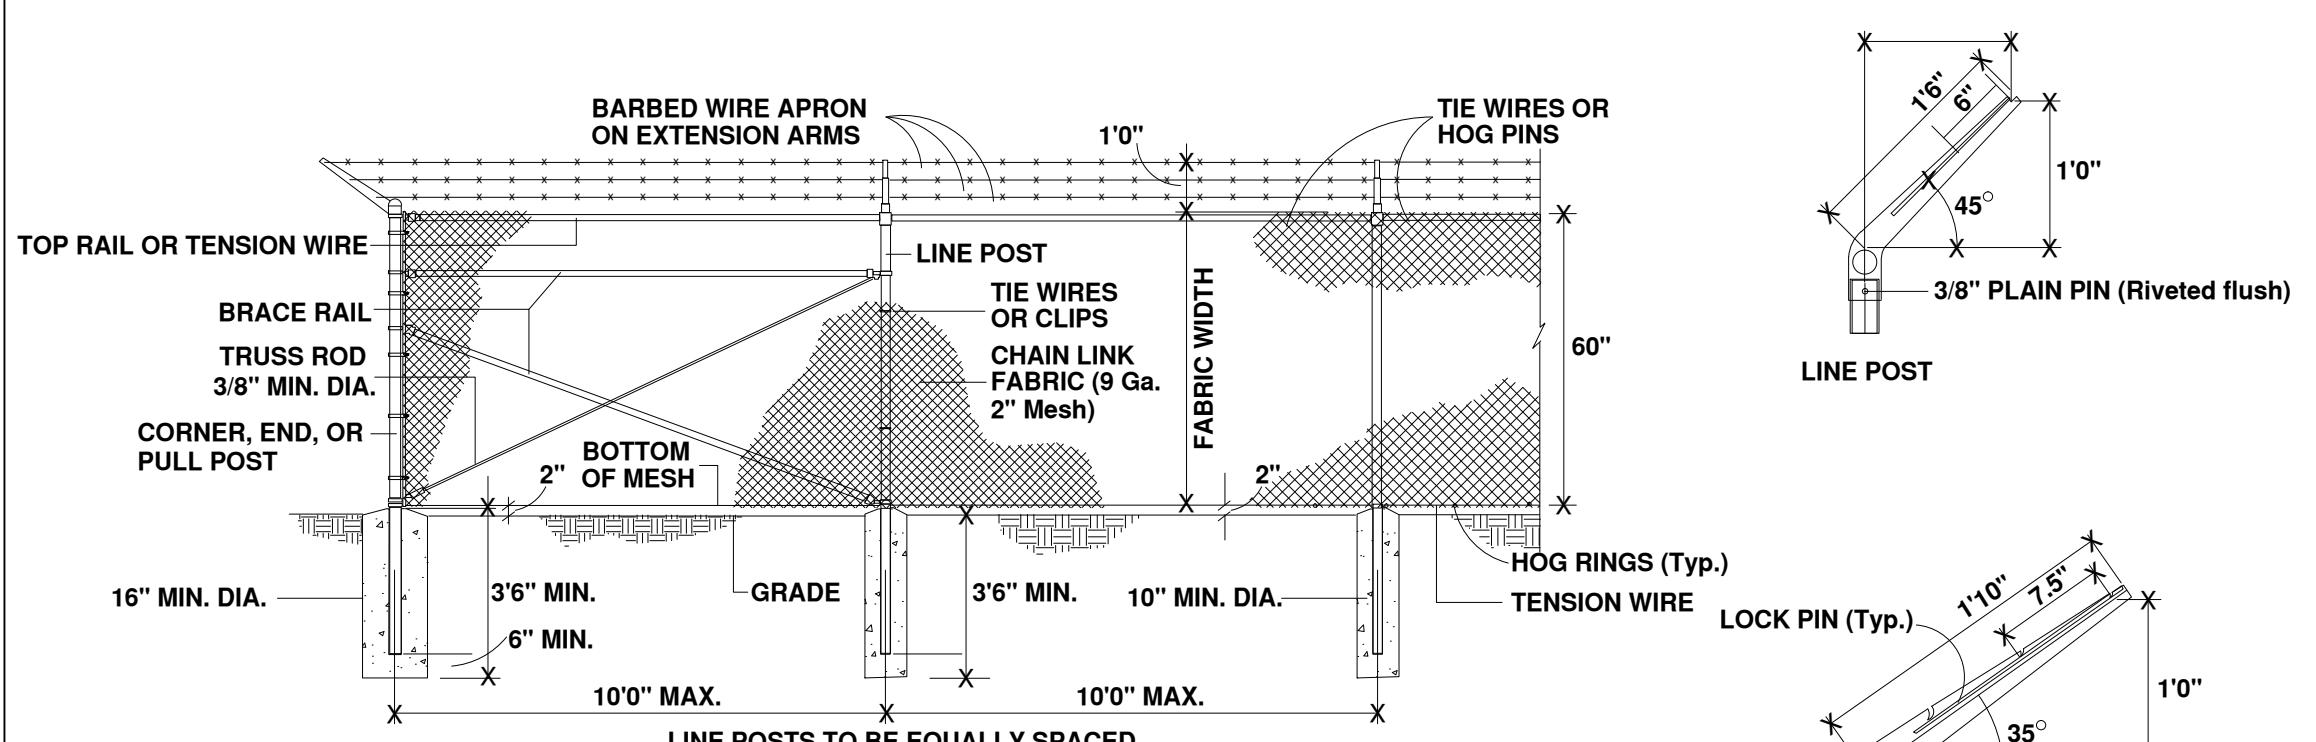
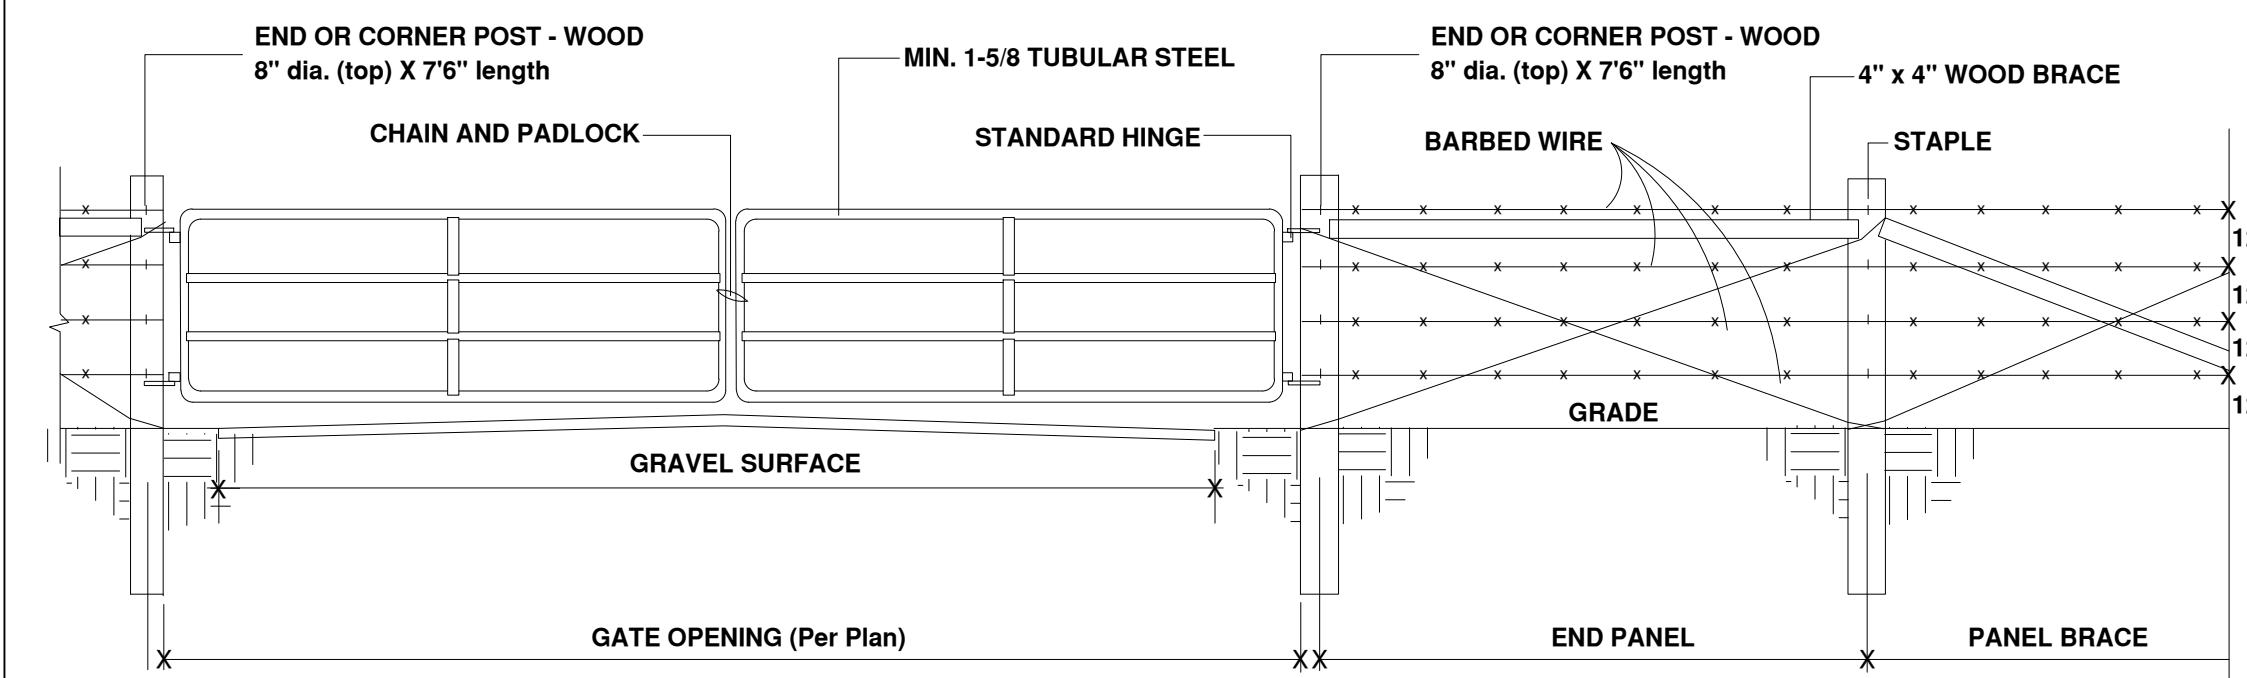
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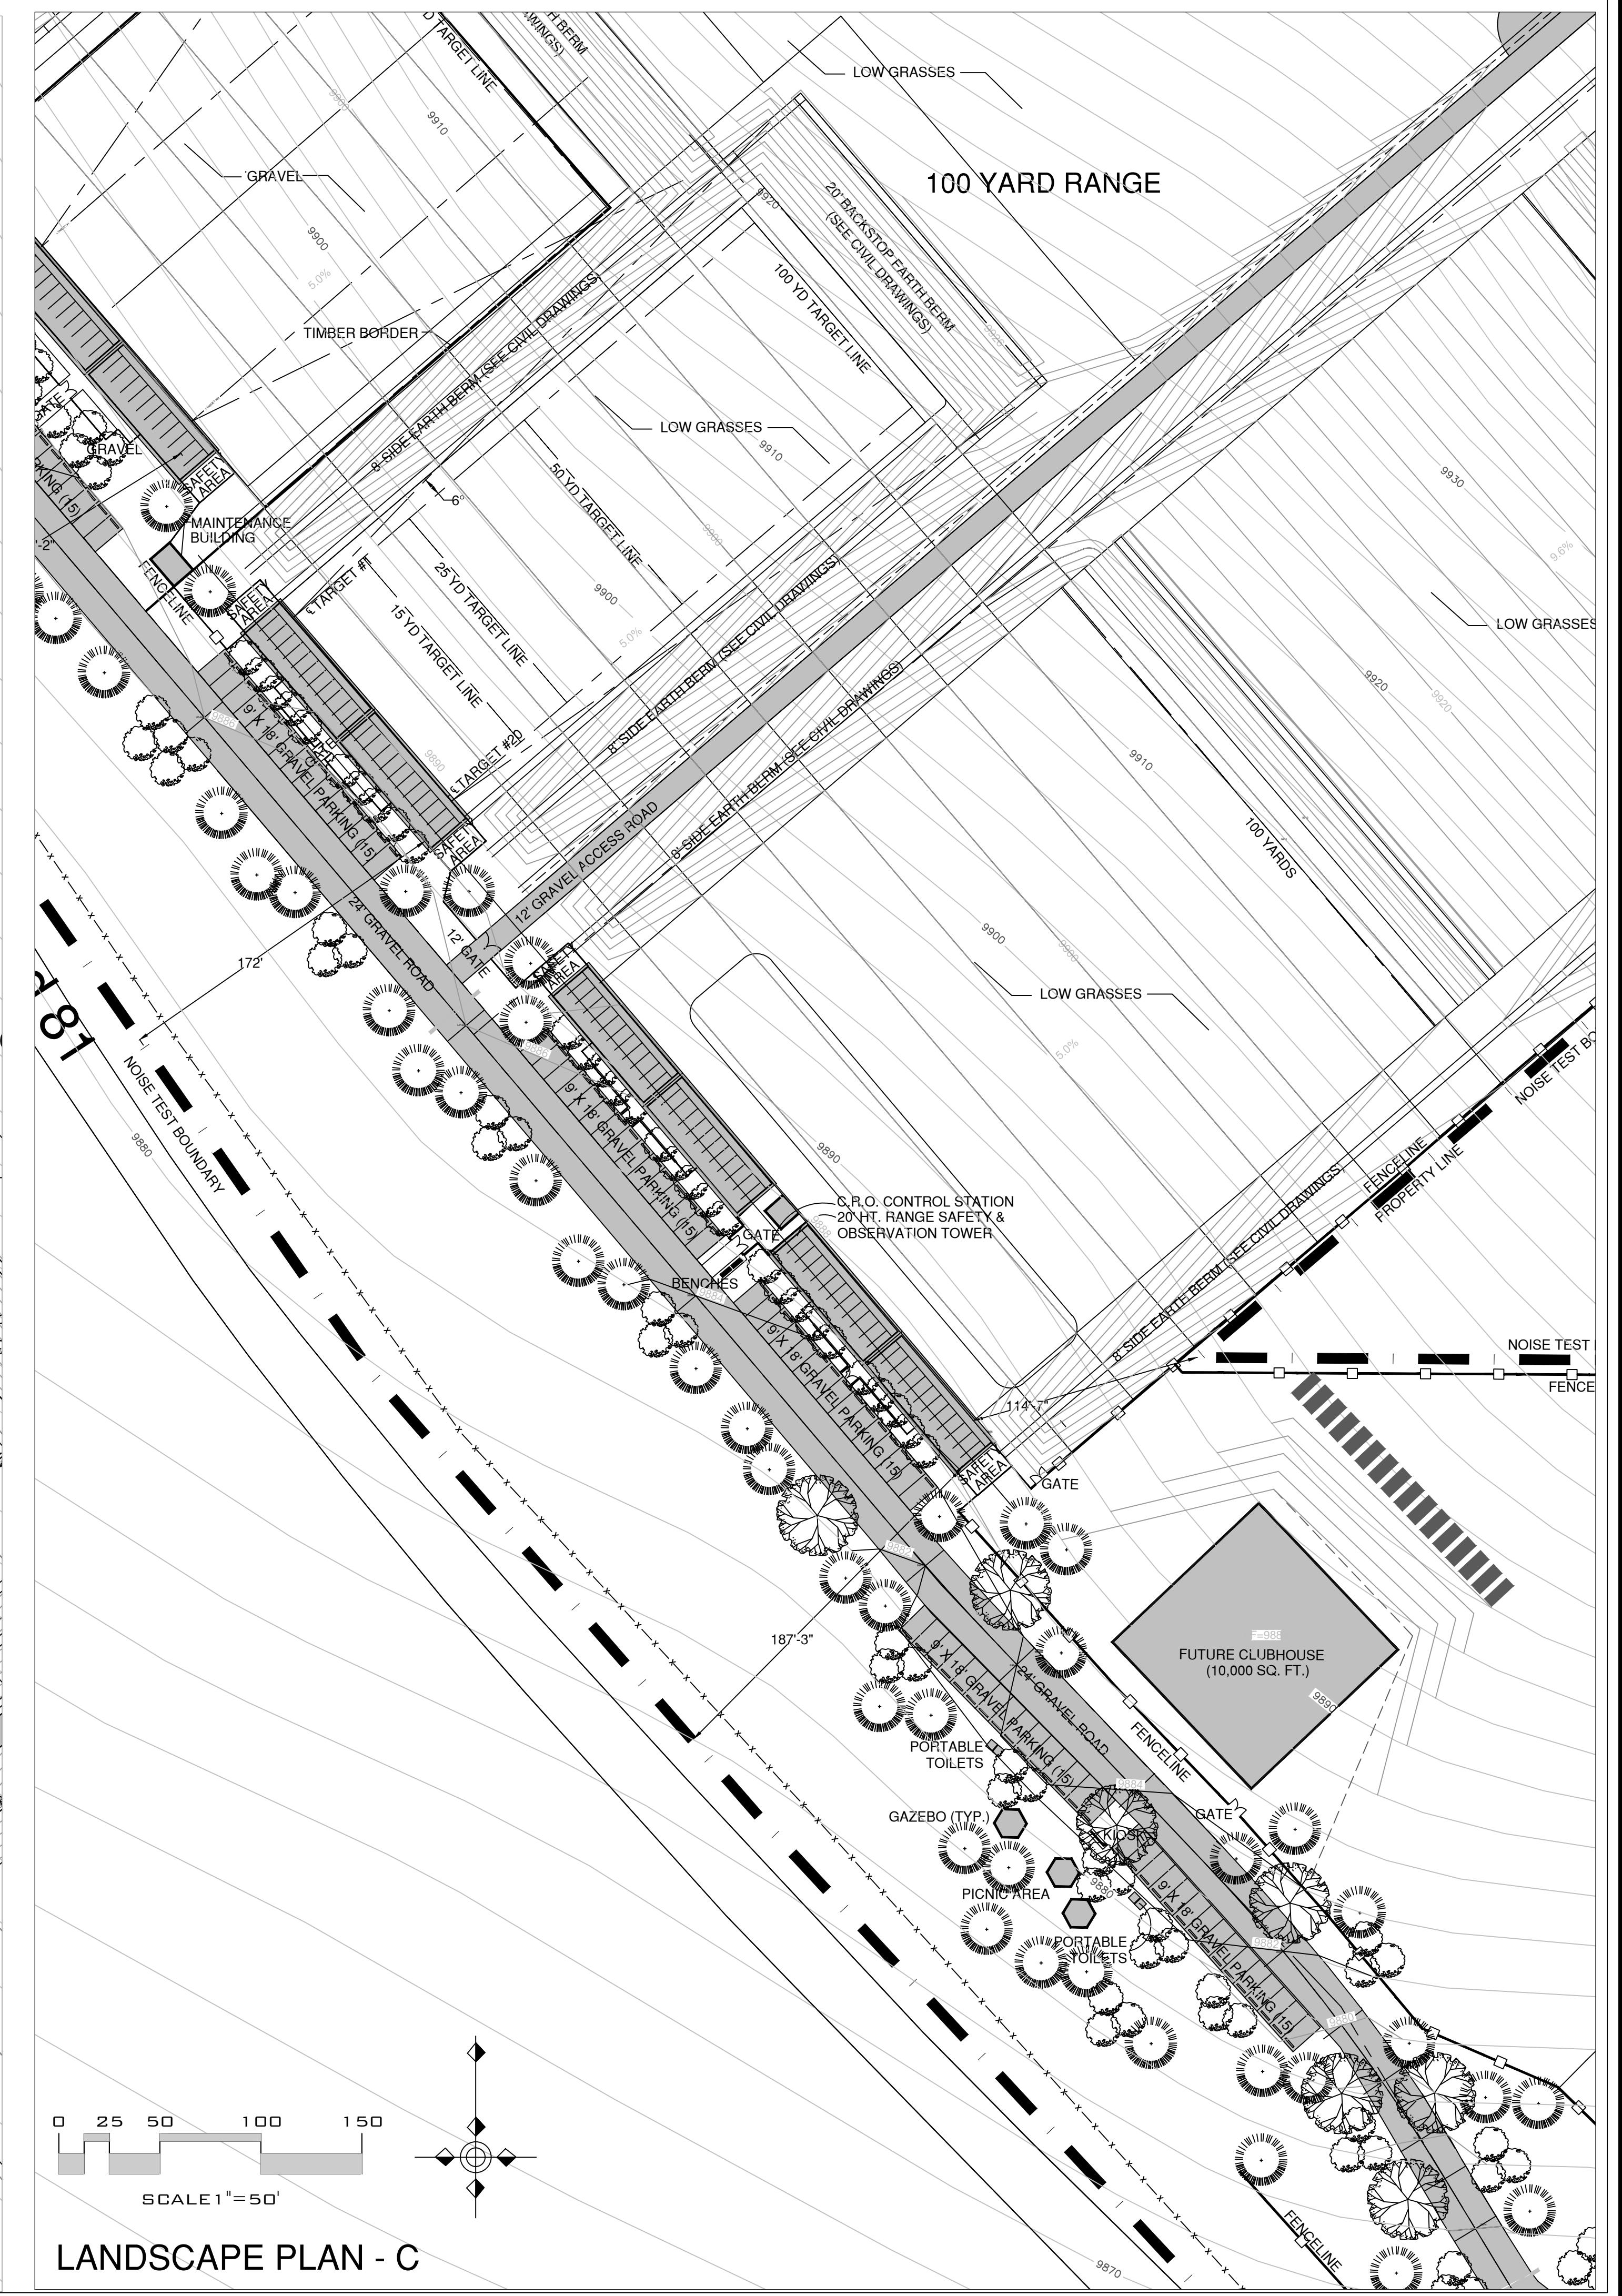
# Gold Camp Shooting Sports Center

## County Road 81

DATE: 11/5/2012
AWN: WFG
ECHECKED: JRA

**ARCHERY AND  
5 TO 100 YARD  
PISTOL RANGE**

MEET NO. 4  
16 OF SHEETS



## Gold Camp Shooting Sports Center County Road 81

TELLER COUNTY, CO

DATE: 11/5/2012  
DRAWN: WFG  
CHECKED: JRA

REVISIONS:  
DATE: BY: COMMENTS:

ARCHERY AND  
15 TO 100 YARD  
PISTOL RANGE



SHEET NO.  
5  
OF 16 SHEETS

**William Gamar**  
& ASSOCIATES, LTD.  
URBAN PLANNING | COMMUNITY DESIGN | LANDSCAPE ARCHITECTURE  
MEMBER: AMERICAN SOCIETY OF LANDSCAPE ARCHITECTS  
731 North Weber Street, Suite 10  
719.633.9700 fax 719.633.4250  
Email: WGMAR@AOL.COM

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# Gold Camp Shooting Sports Center

# County Road 81



## TELLER COUNTY, CO

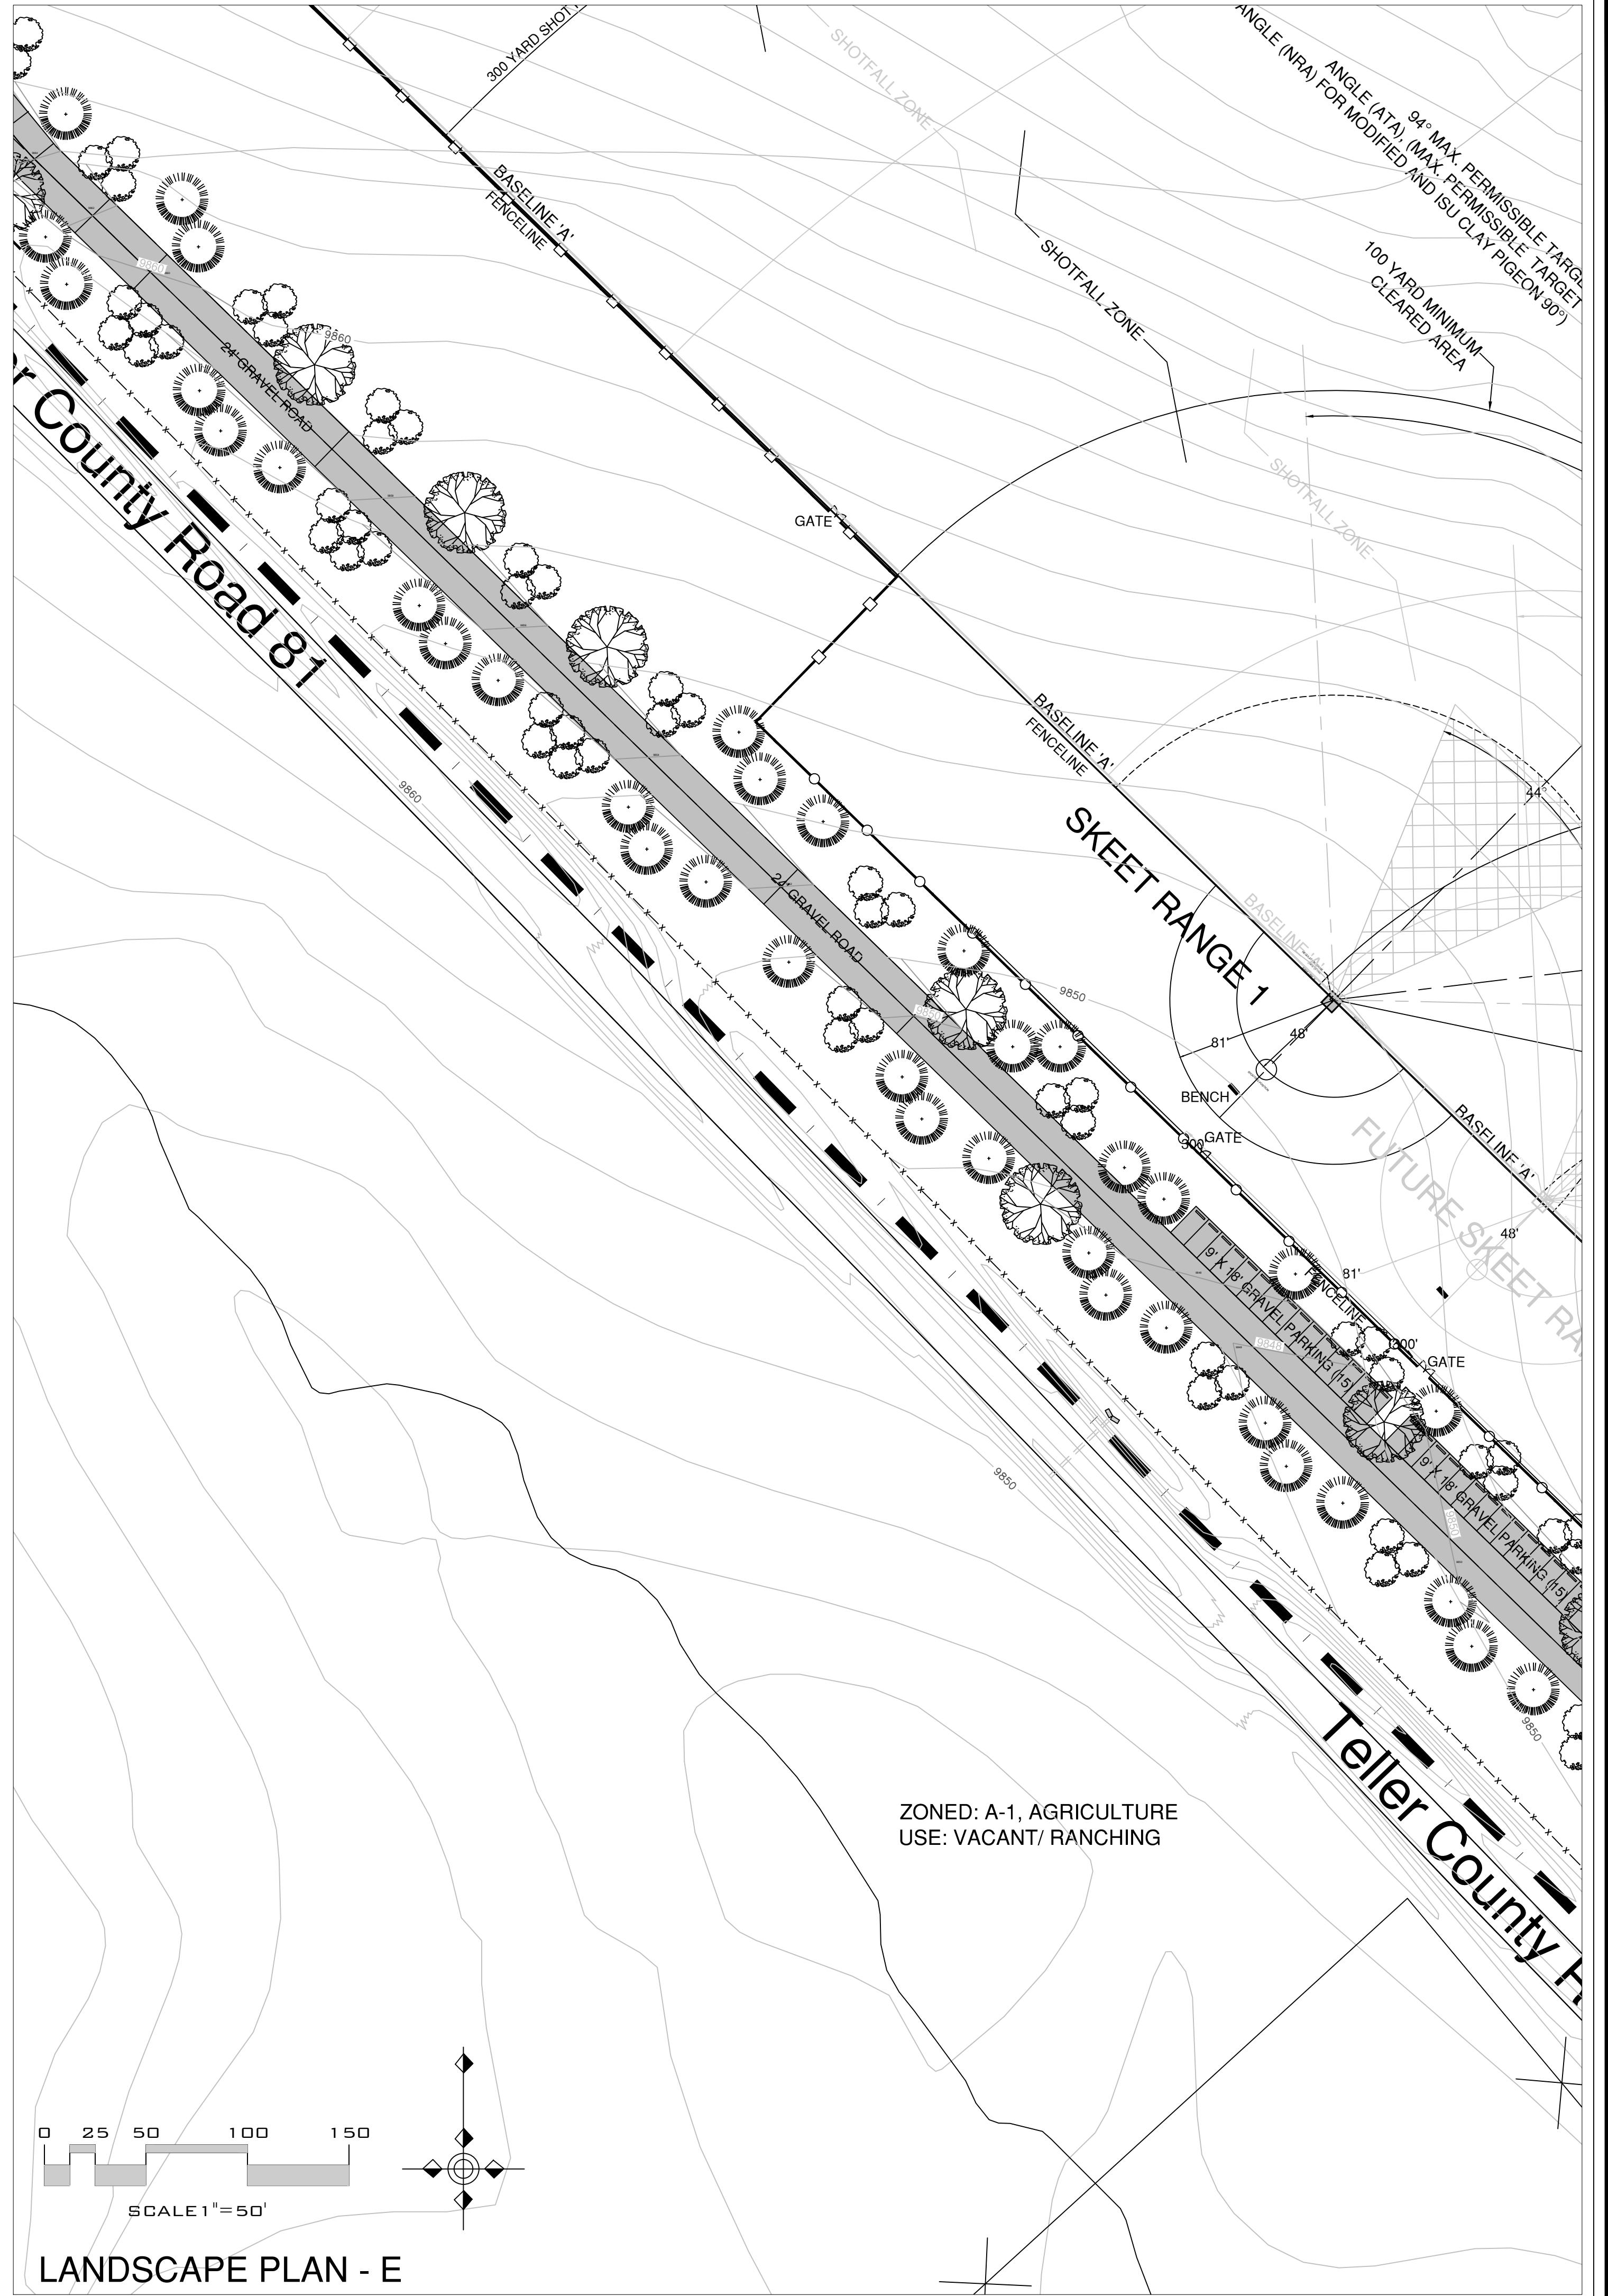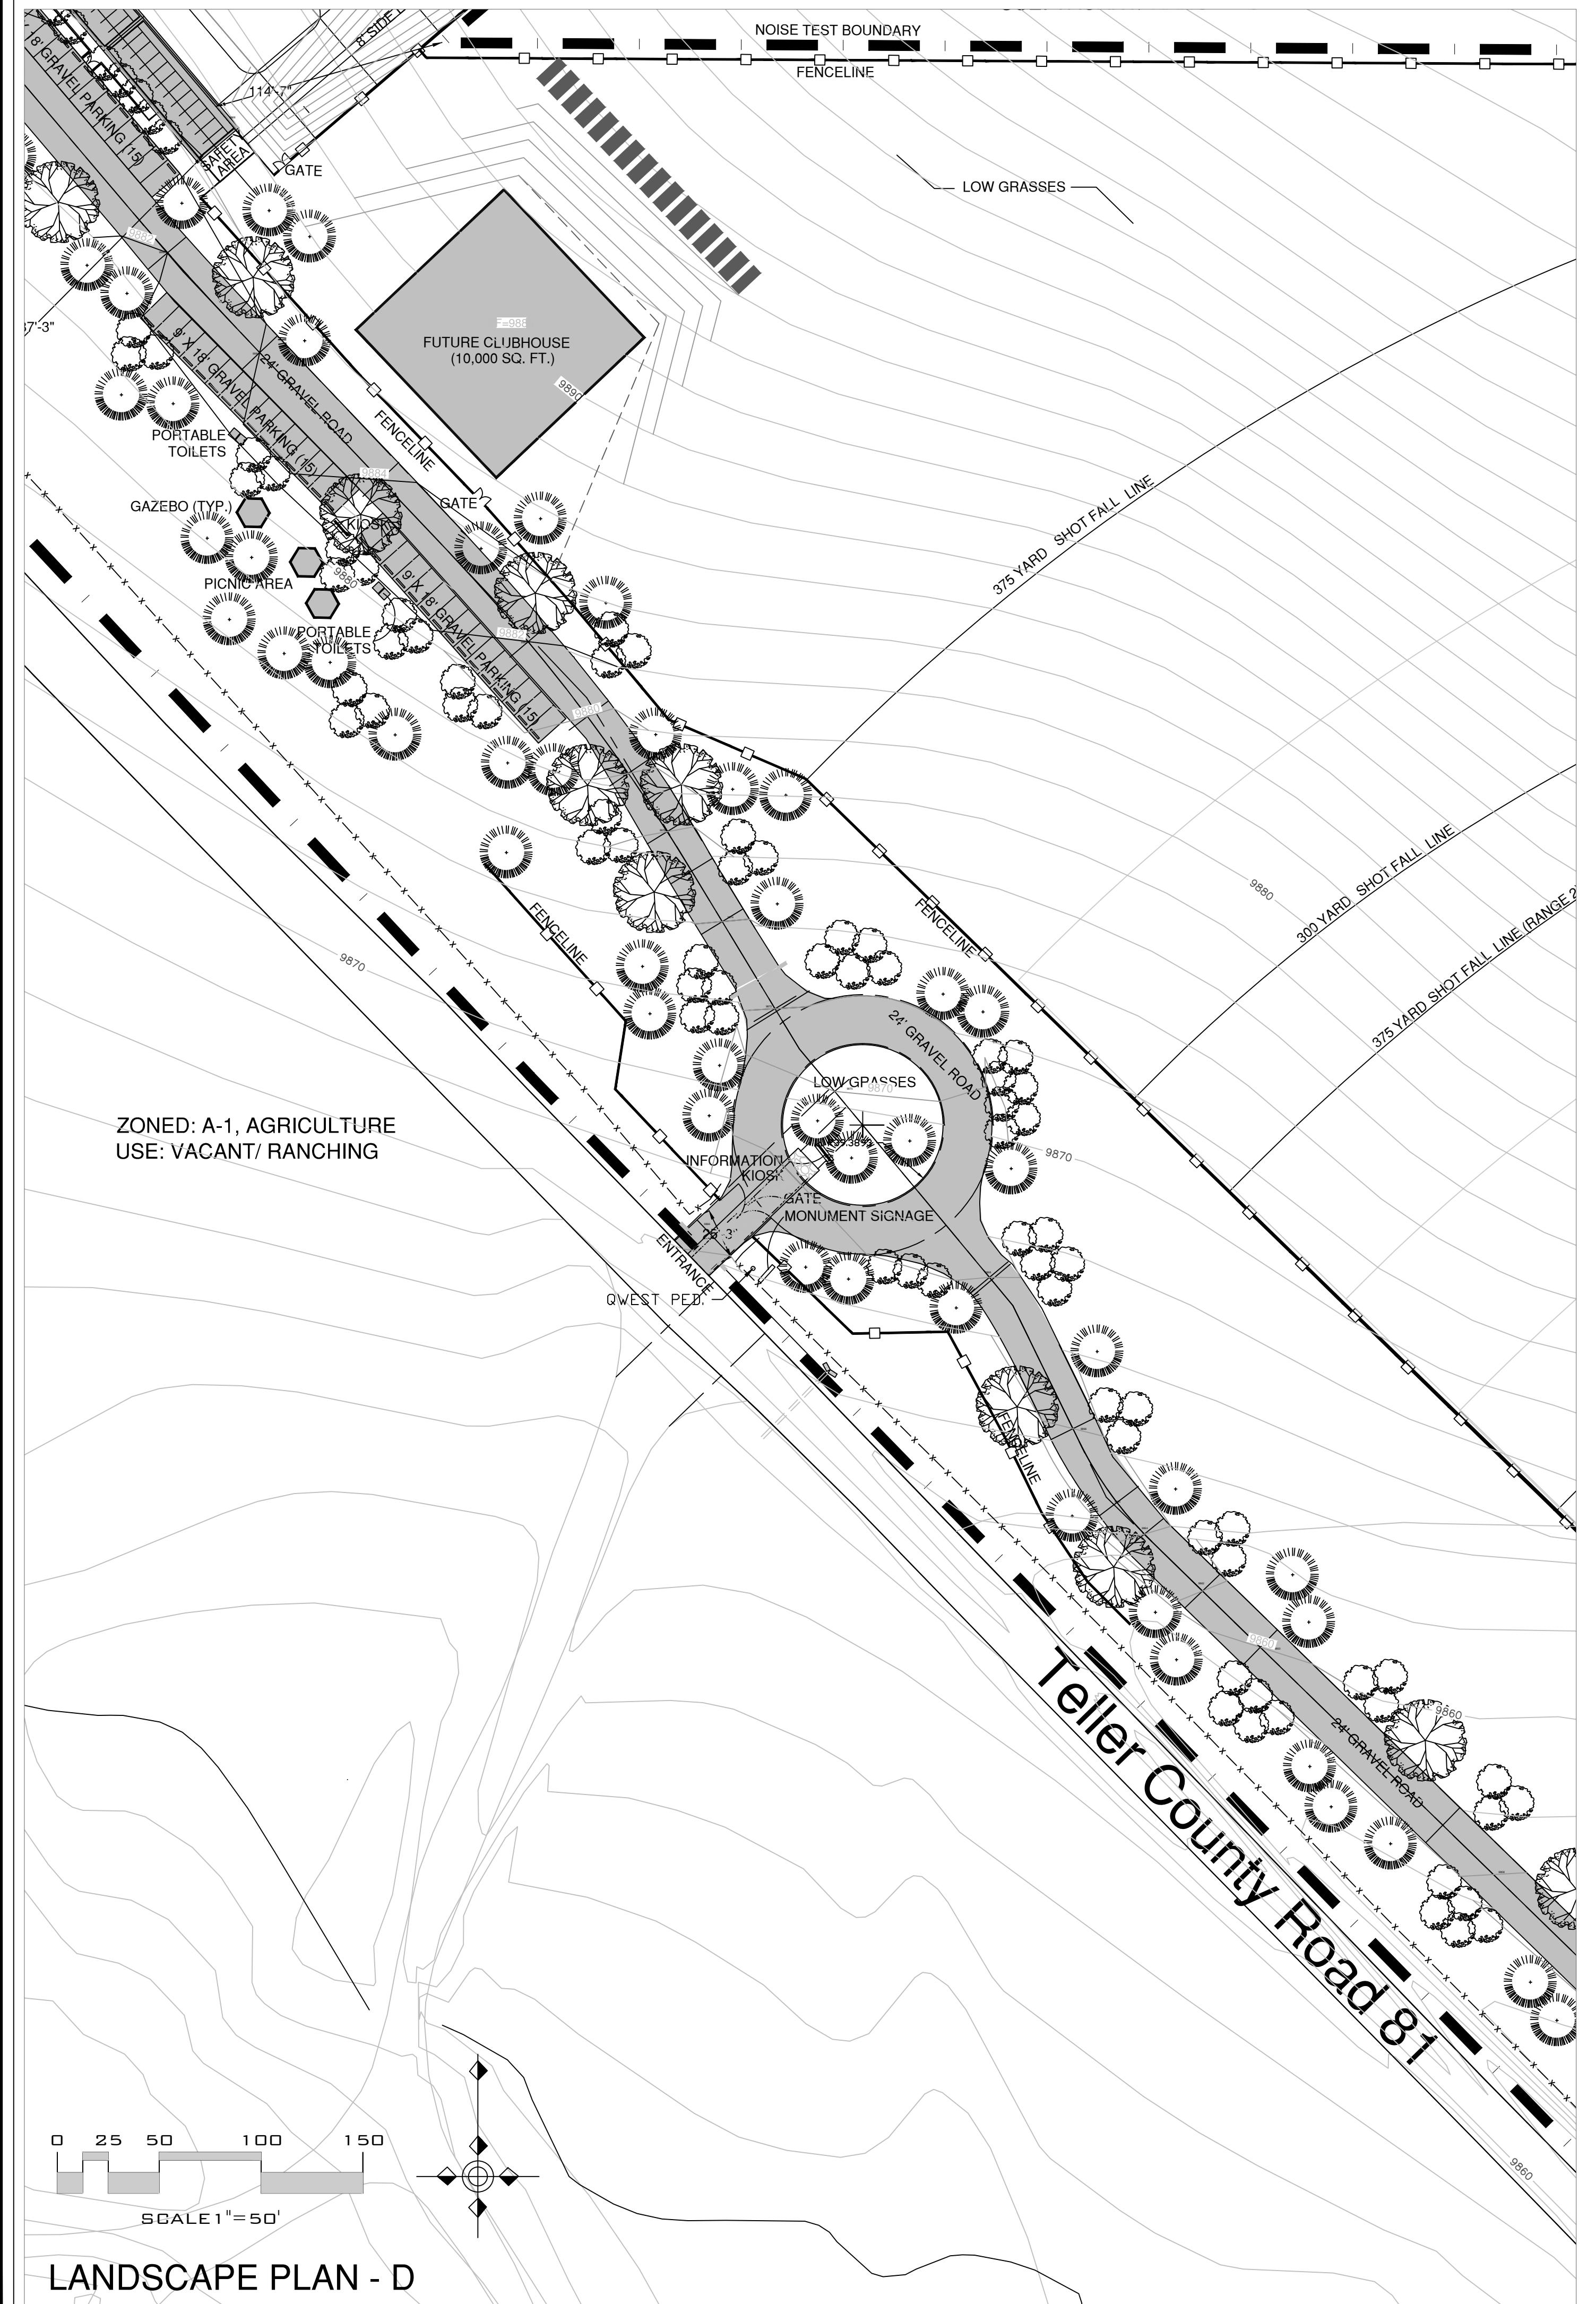DATE: 11/5/2012
AWN: WFG
CHECKED: JRA



REVISIONS:		
DATE:	BY:	COMMENTS:

**ARCHERY AND  
15 TO 100 YARD  
PISTOL RANGE**

HEET NO. 6 OF 16 SHEETS

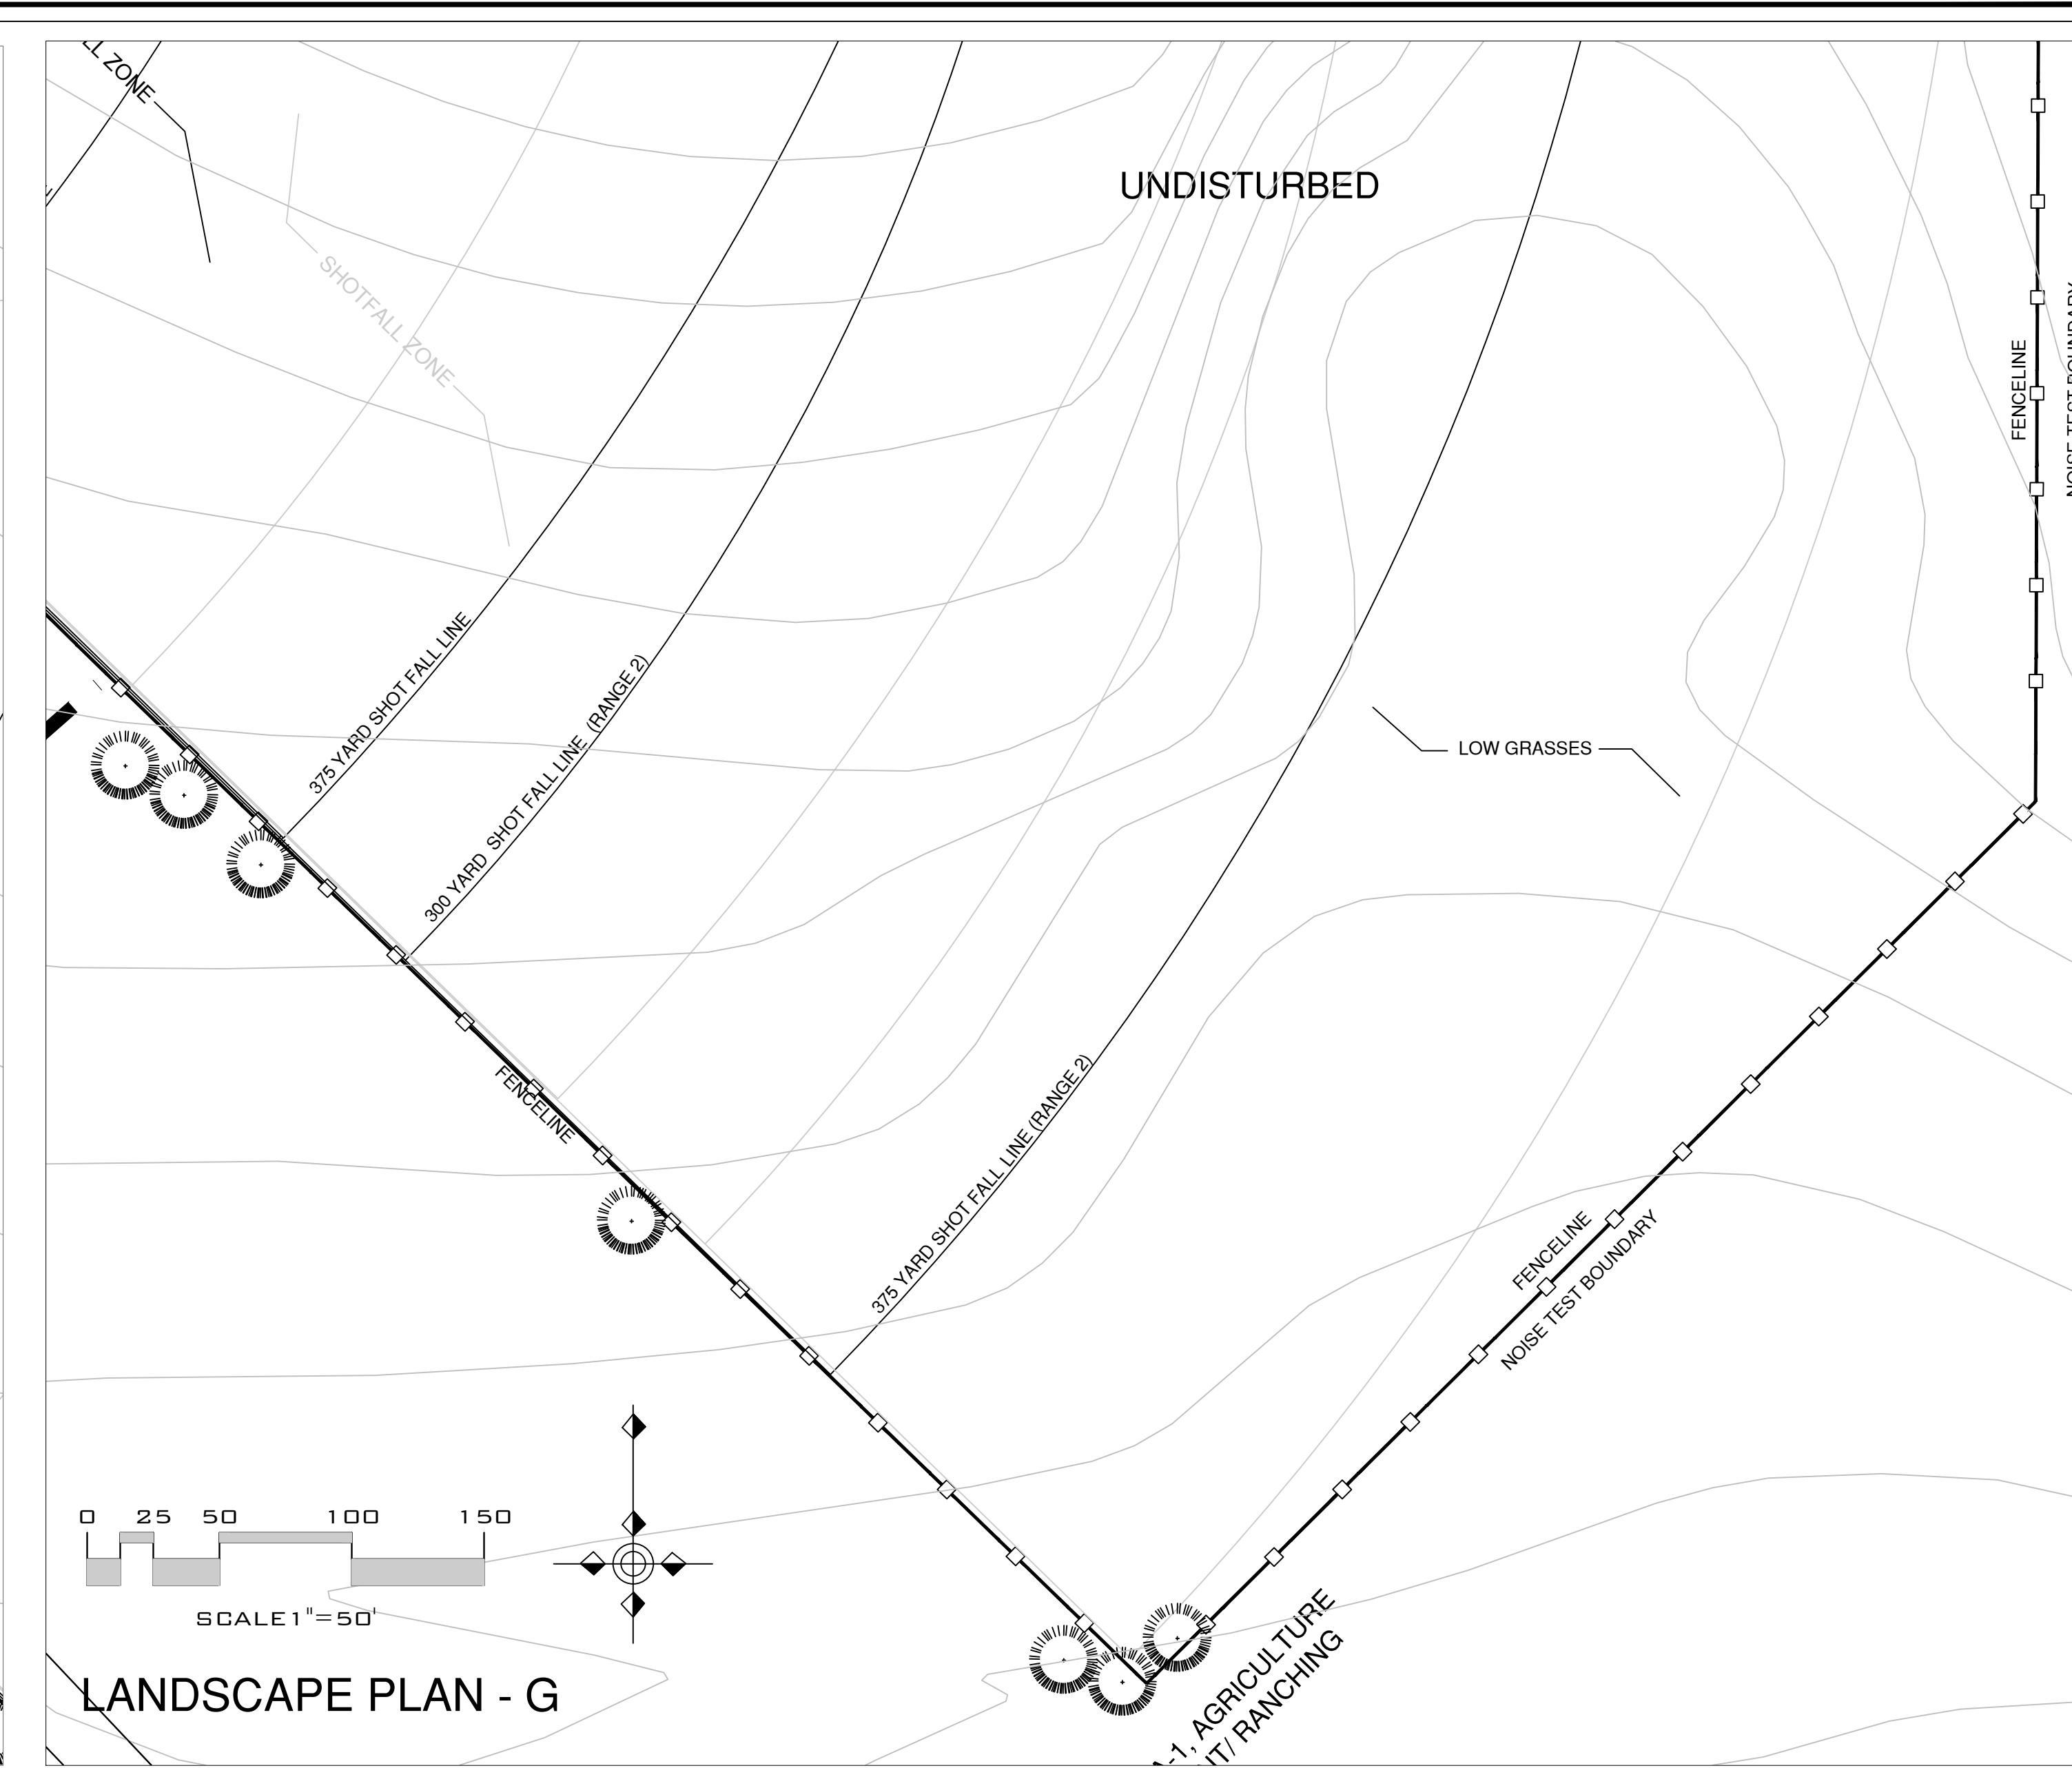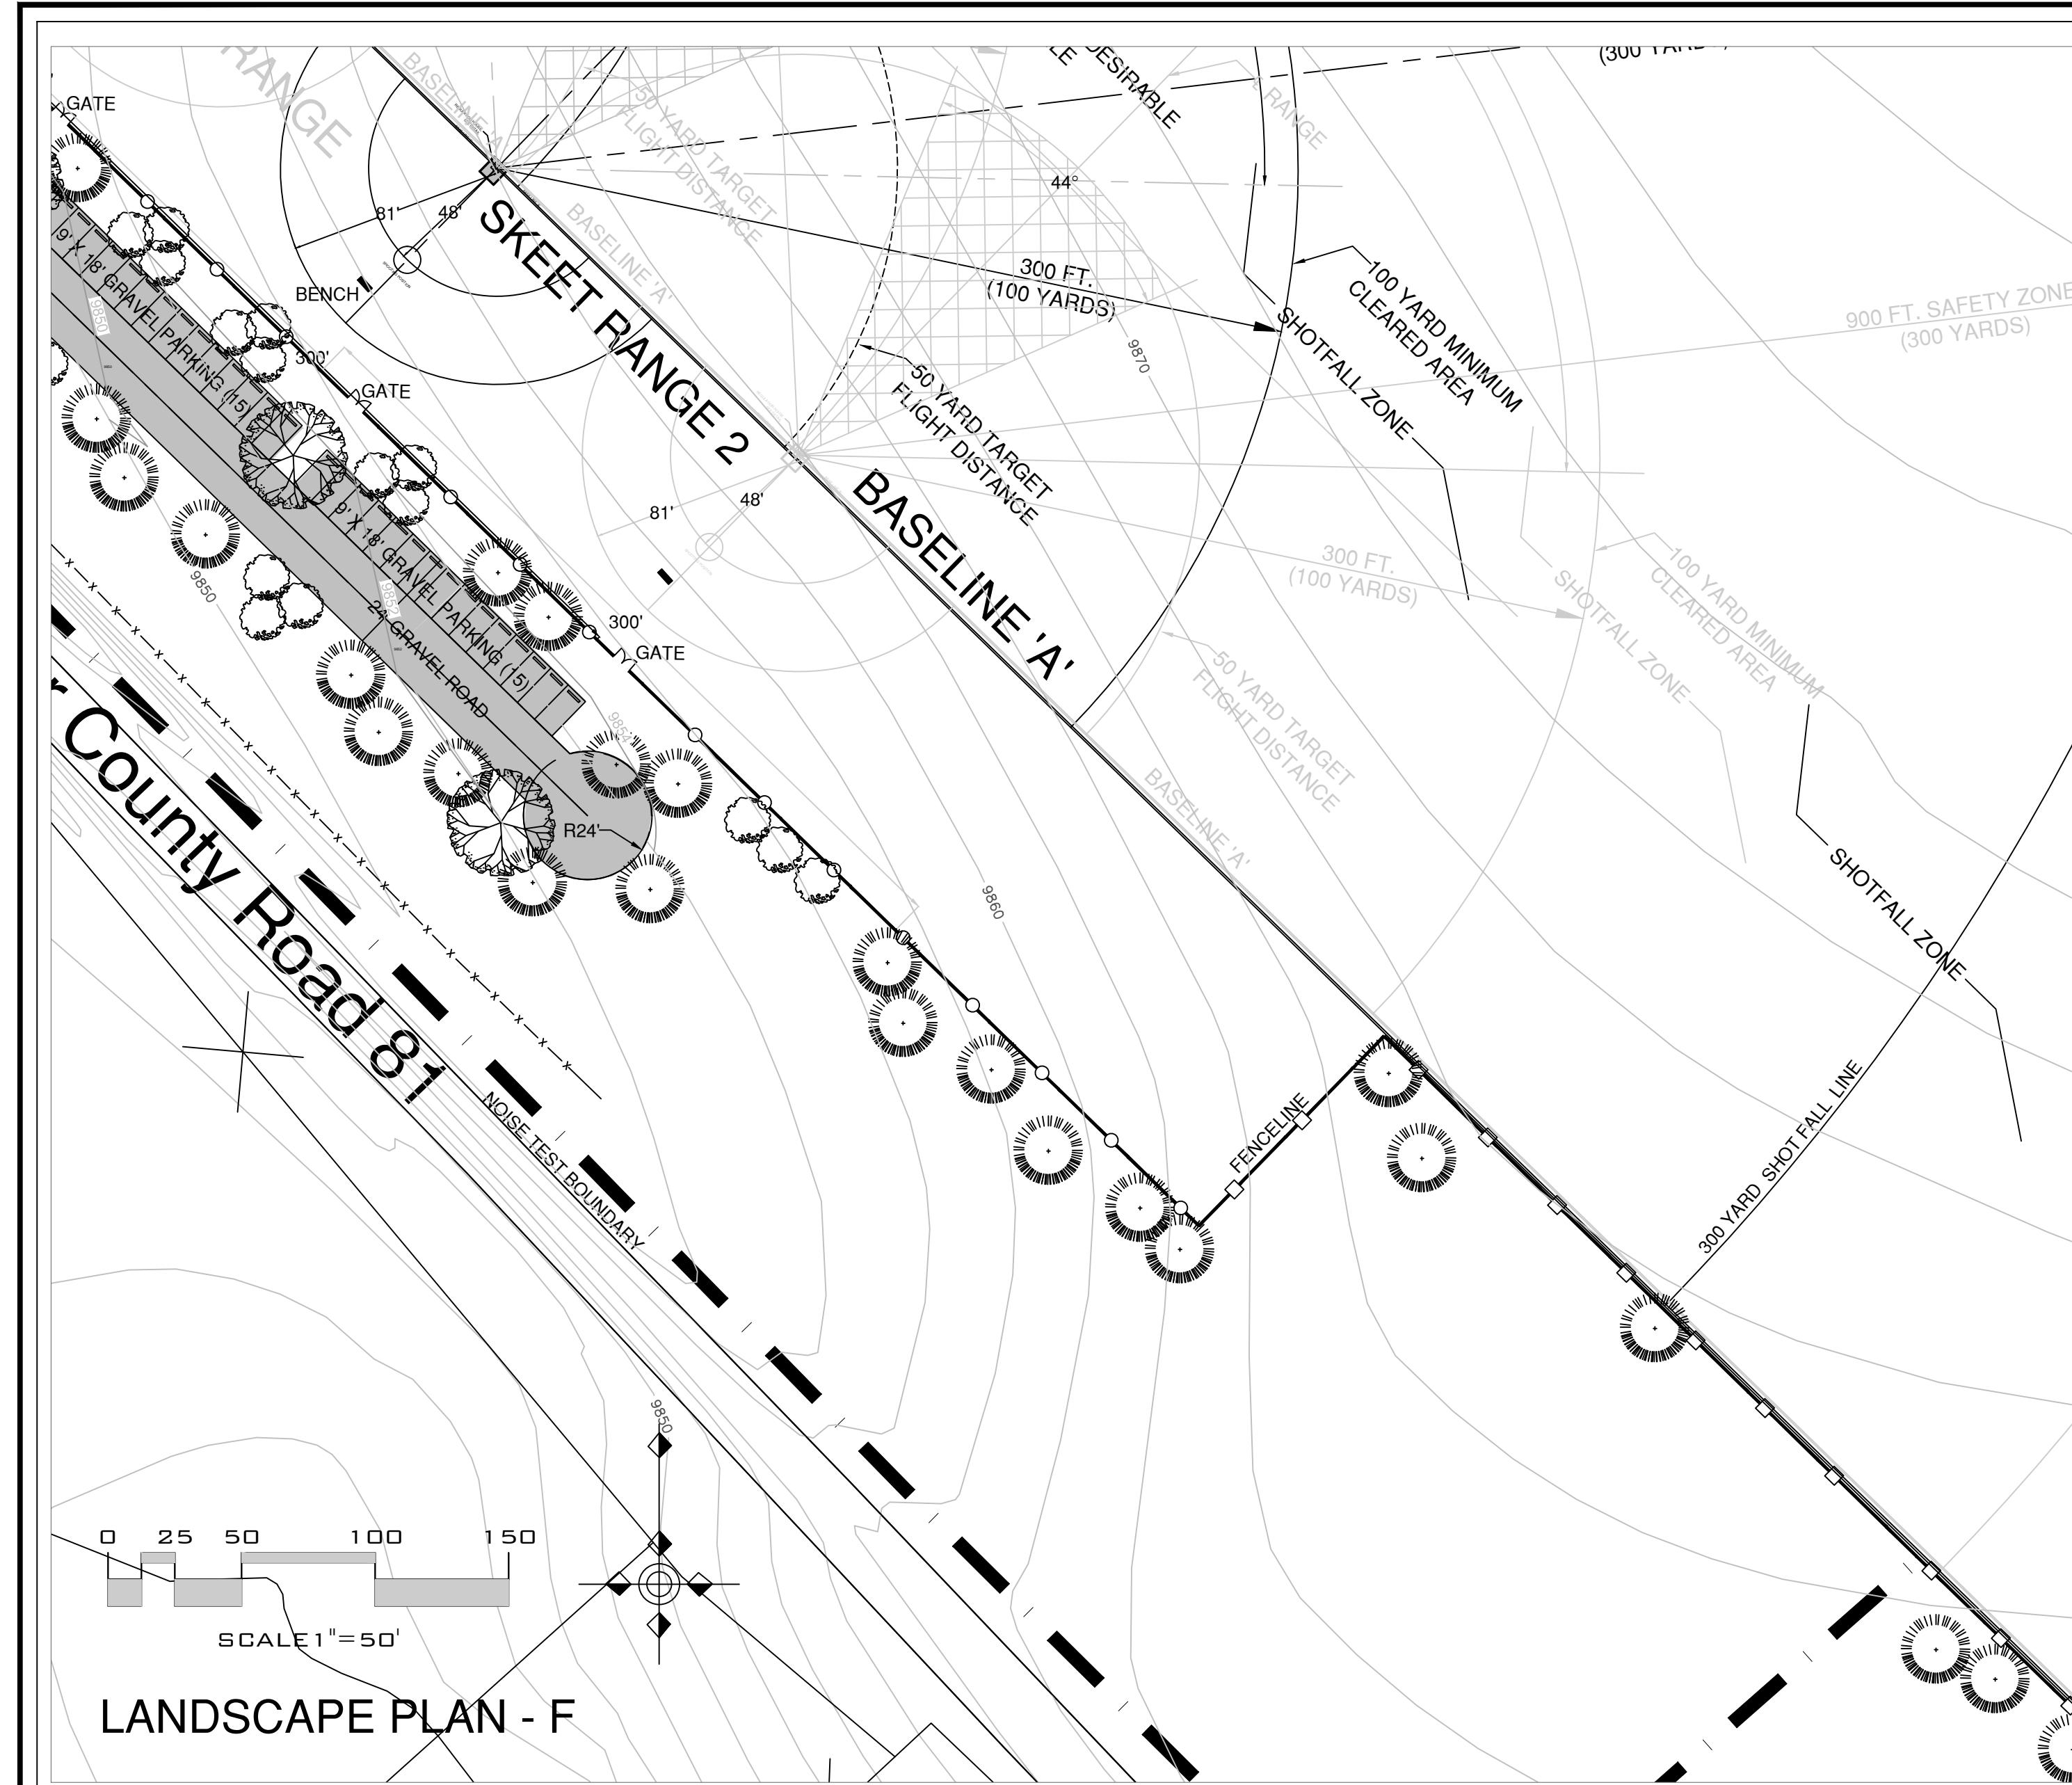


#### LANDSCAPE DETAILS & NOTES:

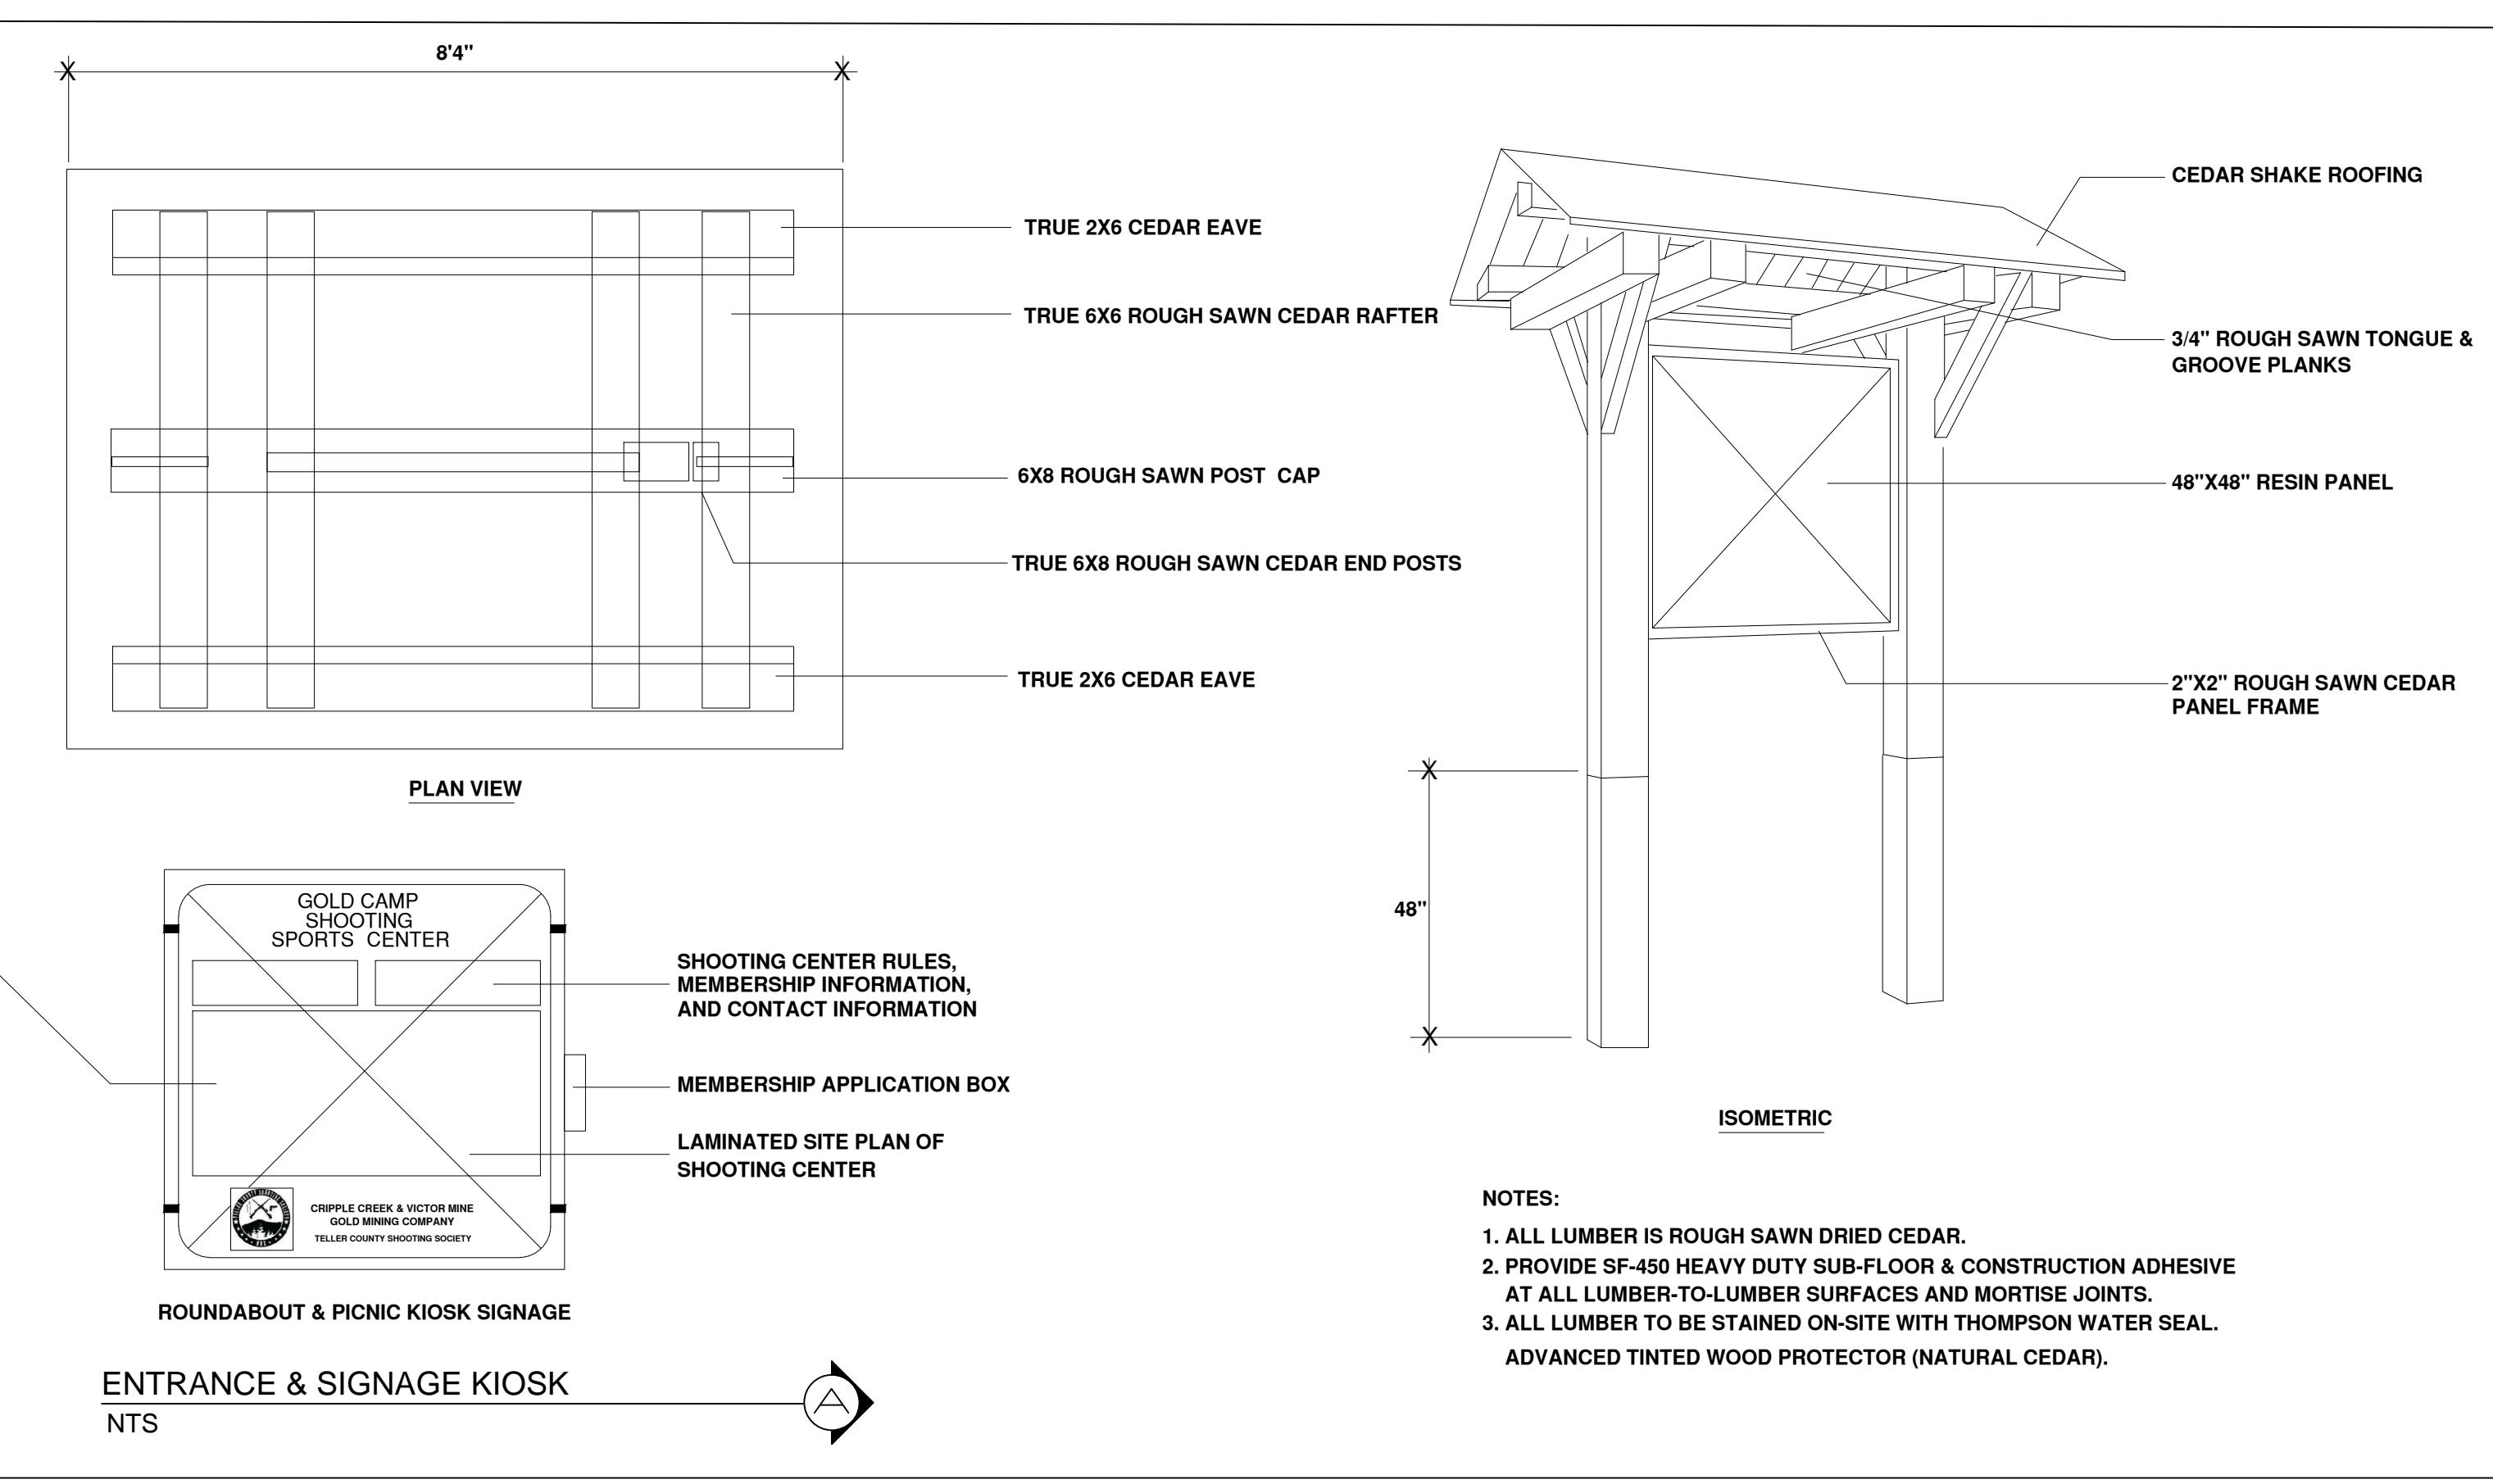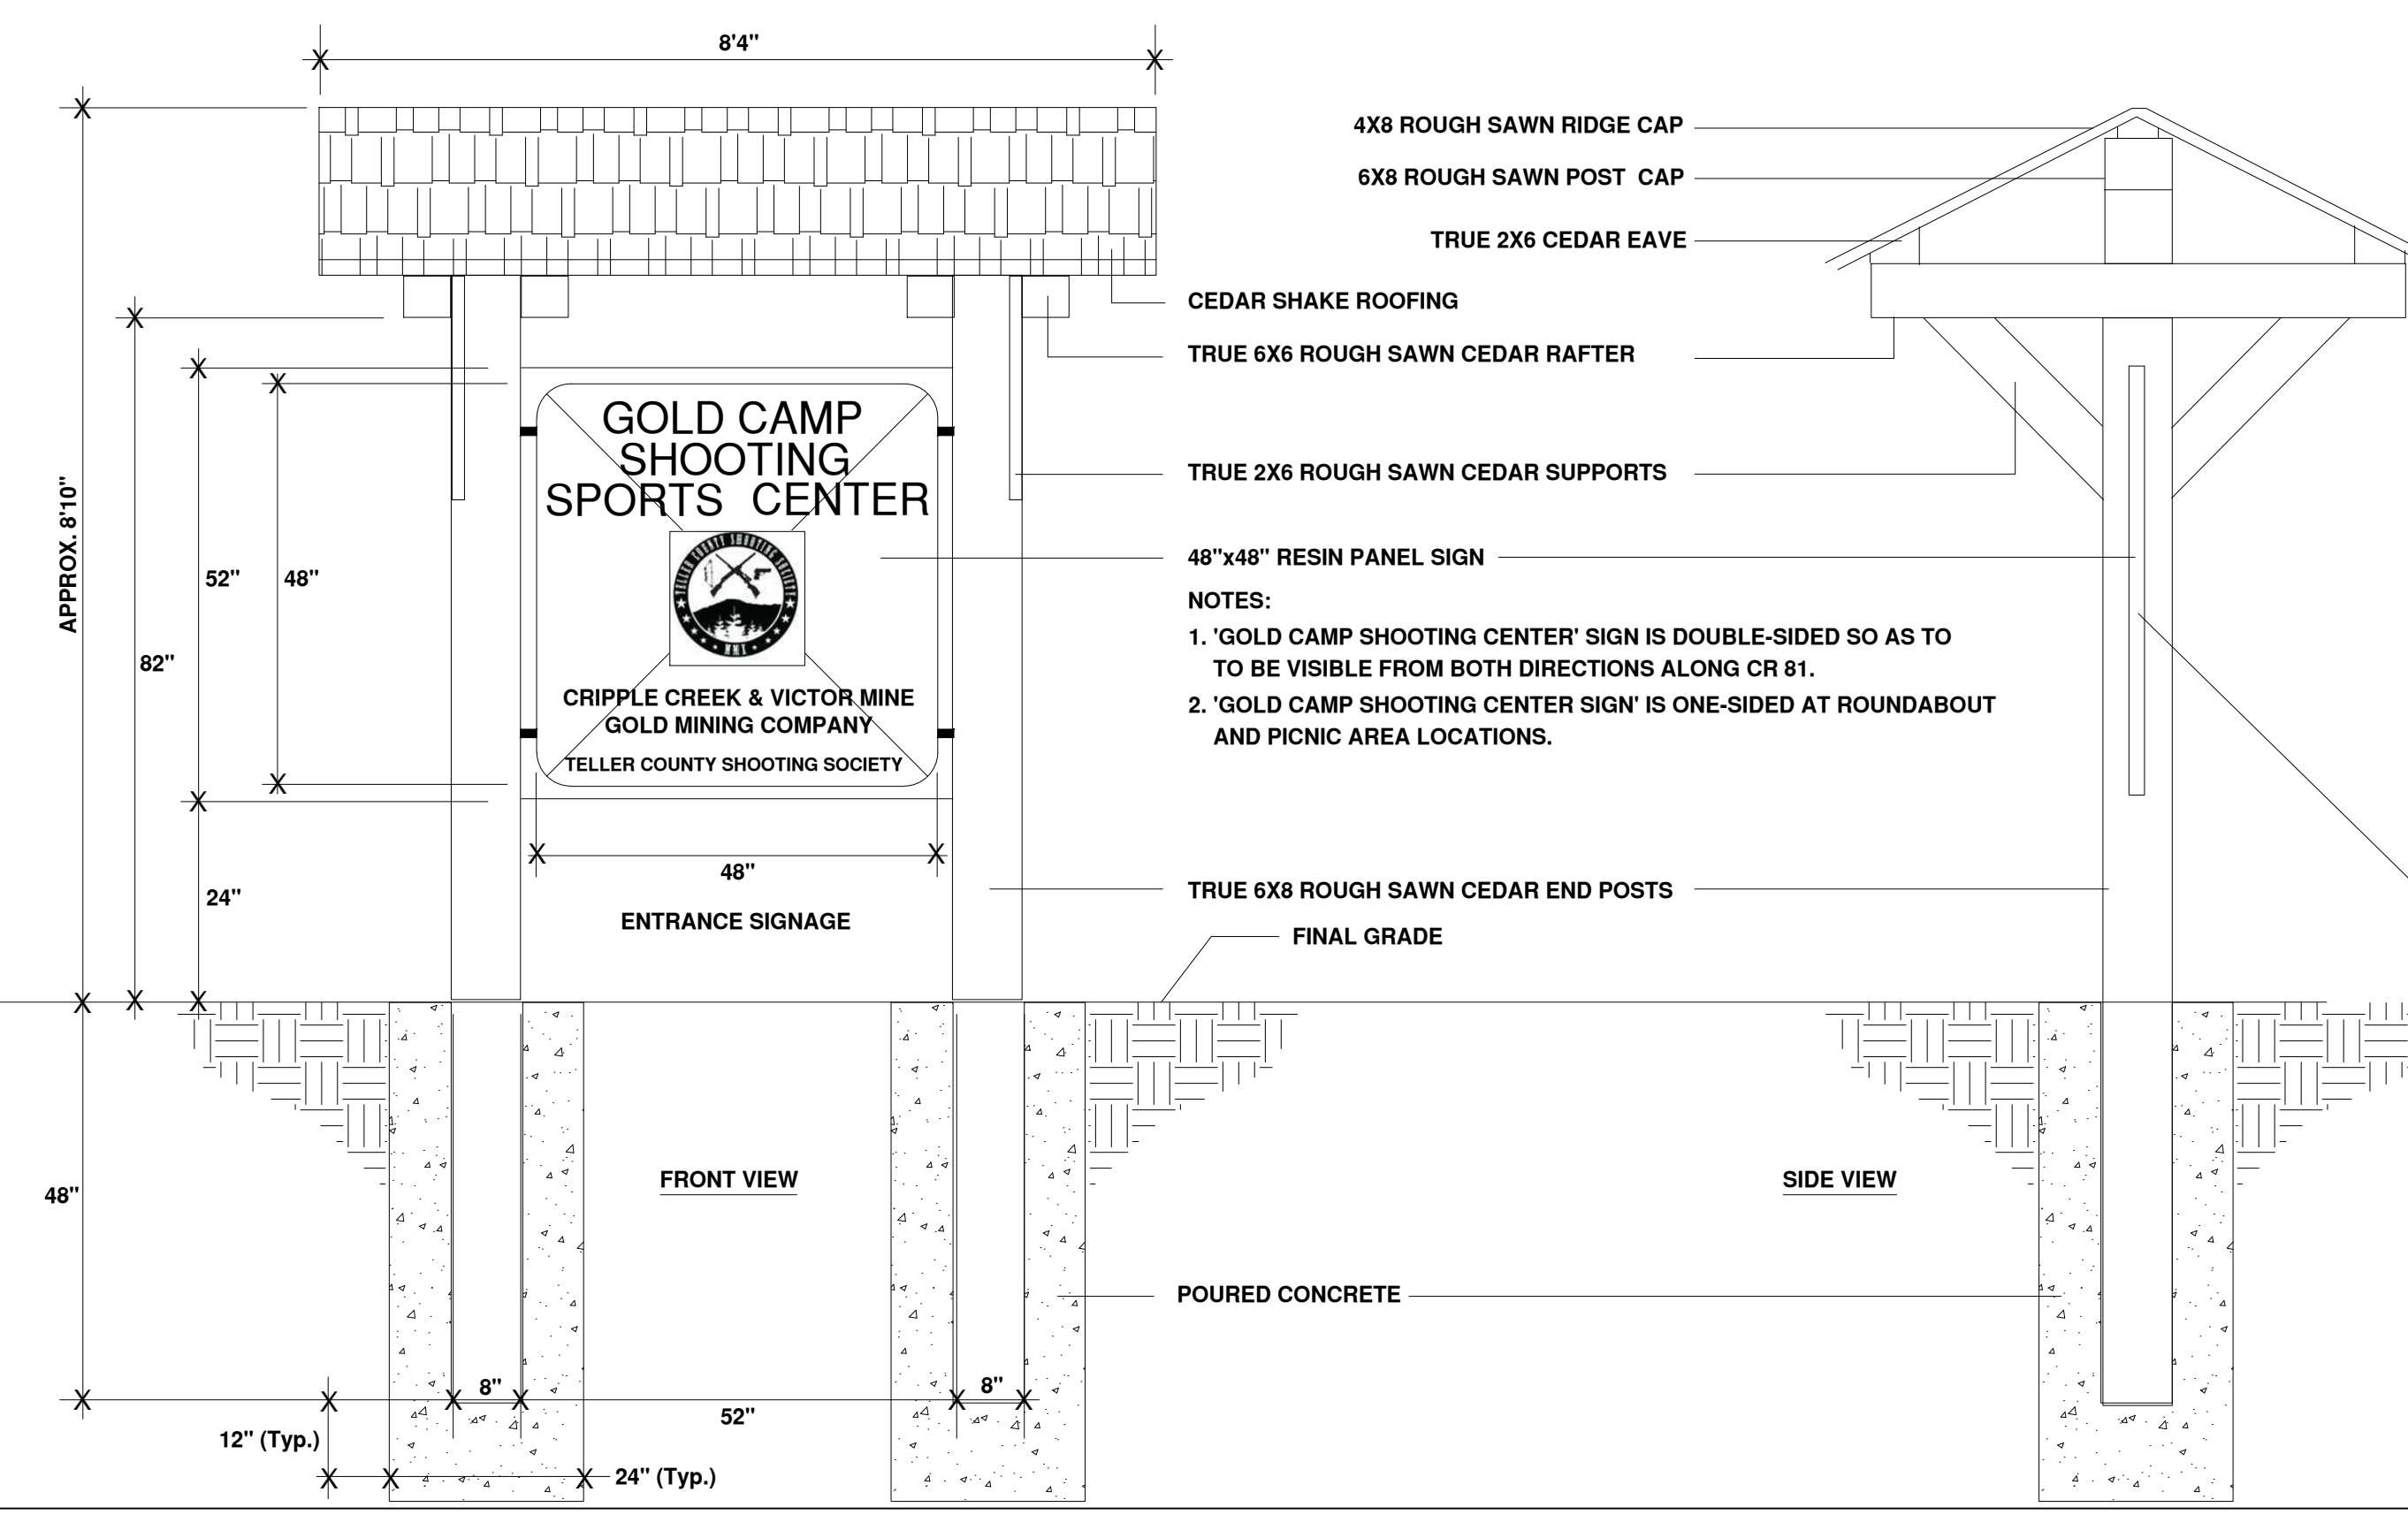

## Gold Camp Shooting Sports Center

County Road 81

TELLER COUNTY, CO

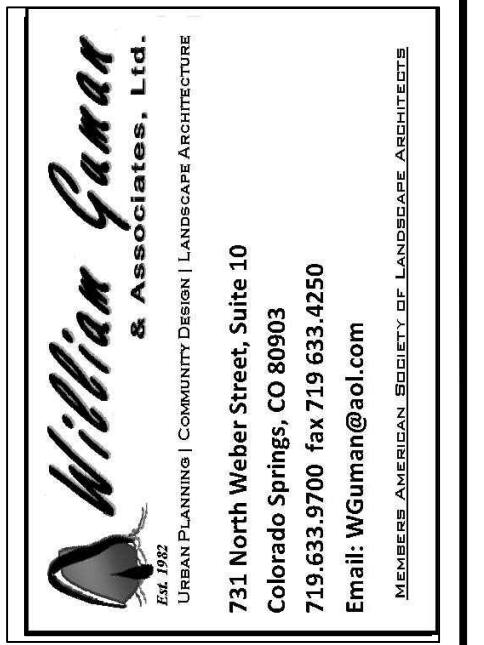


DATE: 11/5/2012  
DRAWN: WFG  
CHECKED: JRA

REVISIONS:  
DATE: BY: COMMENTS:

ARCHERY AND  
15 TO 100 YARD  
PISTOL RANGE


7  
16  
SHEET NO. OF SHEETS

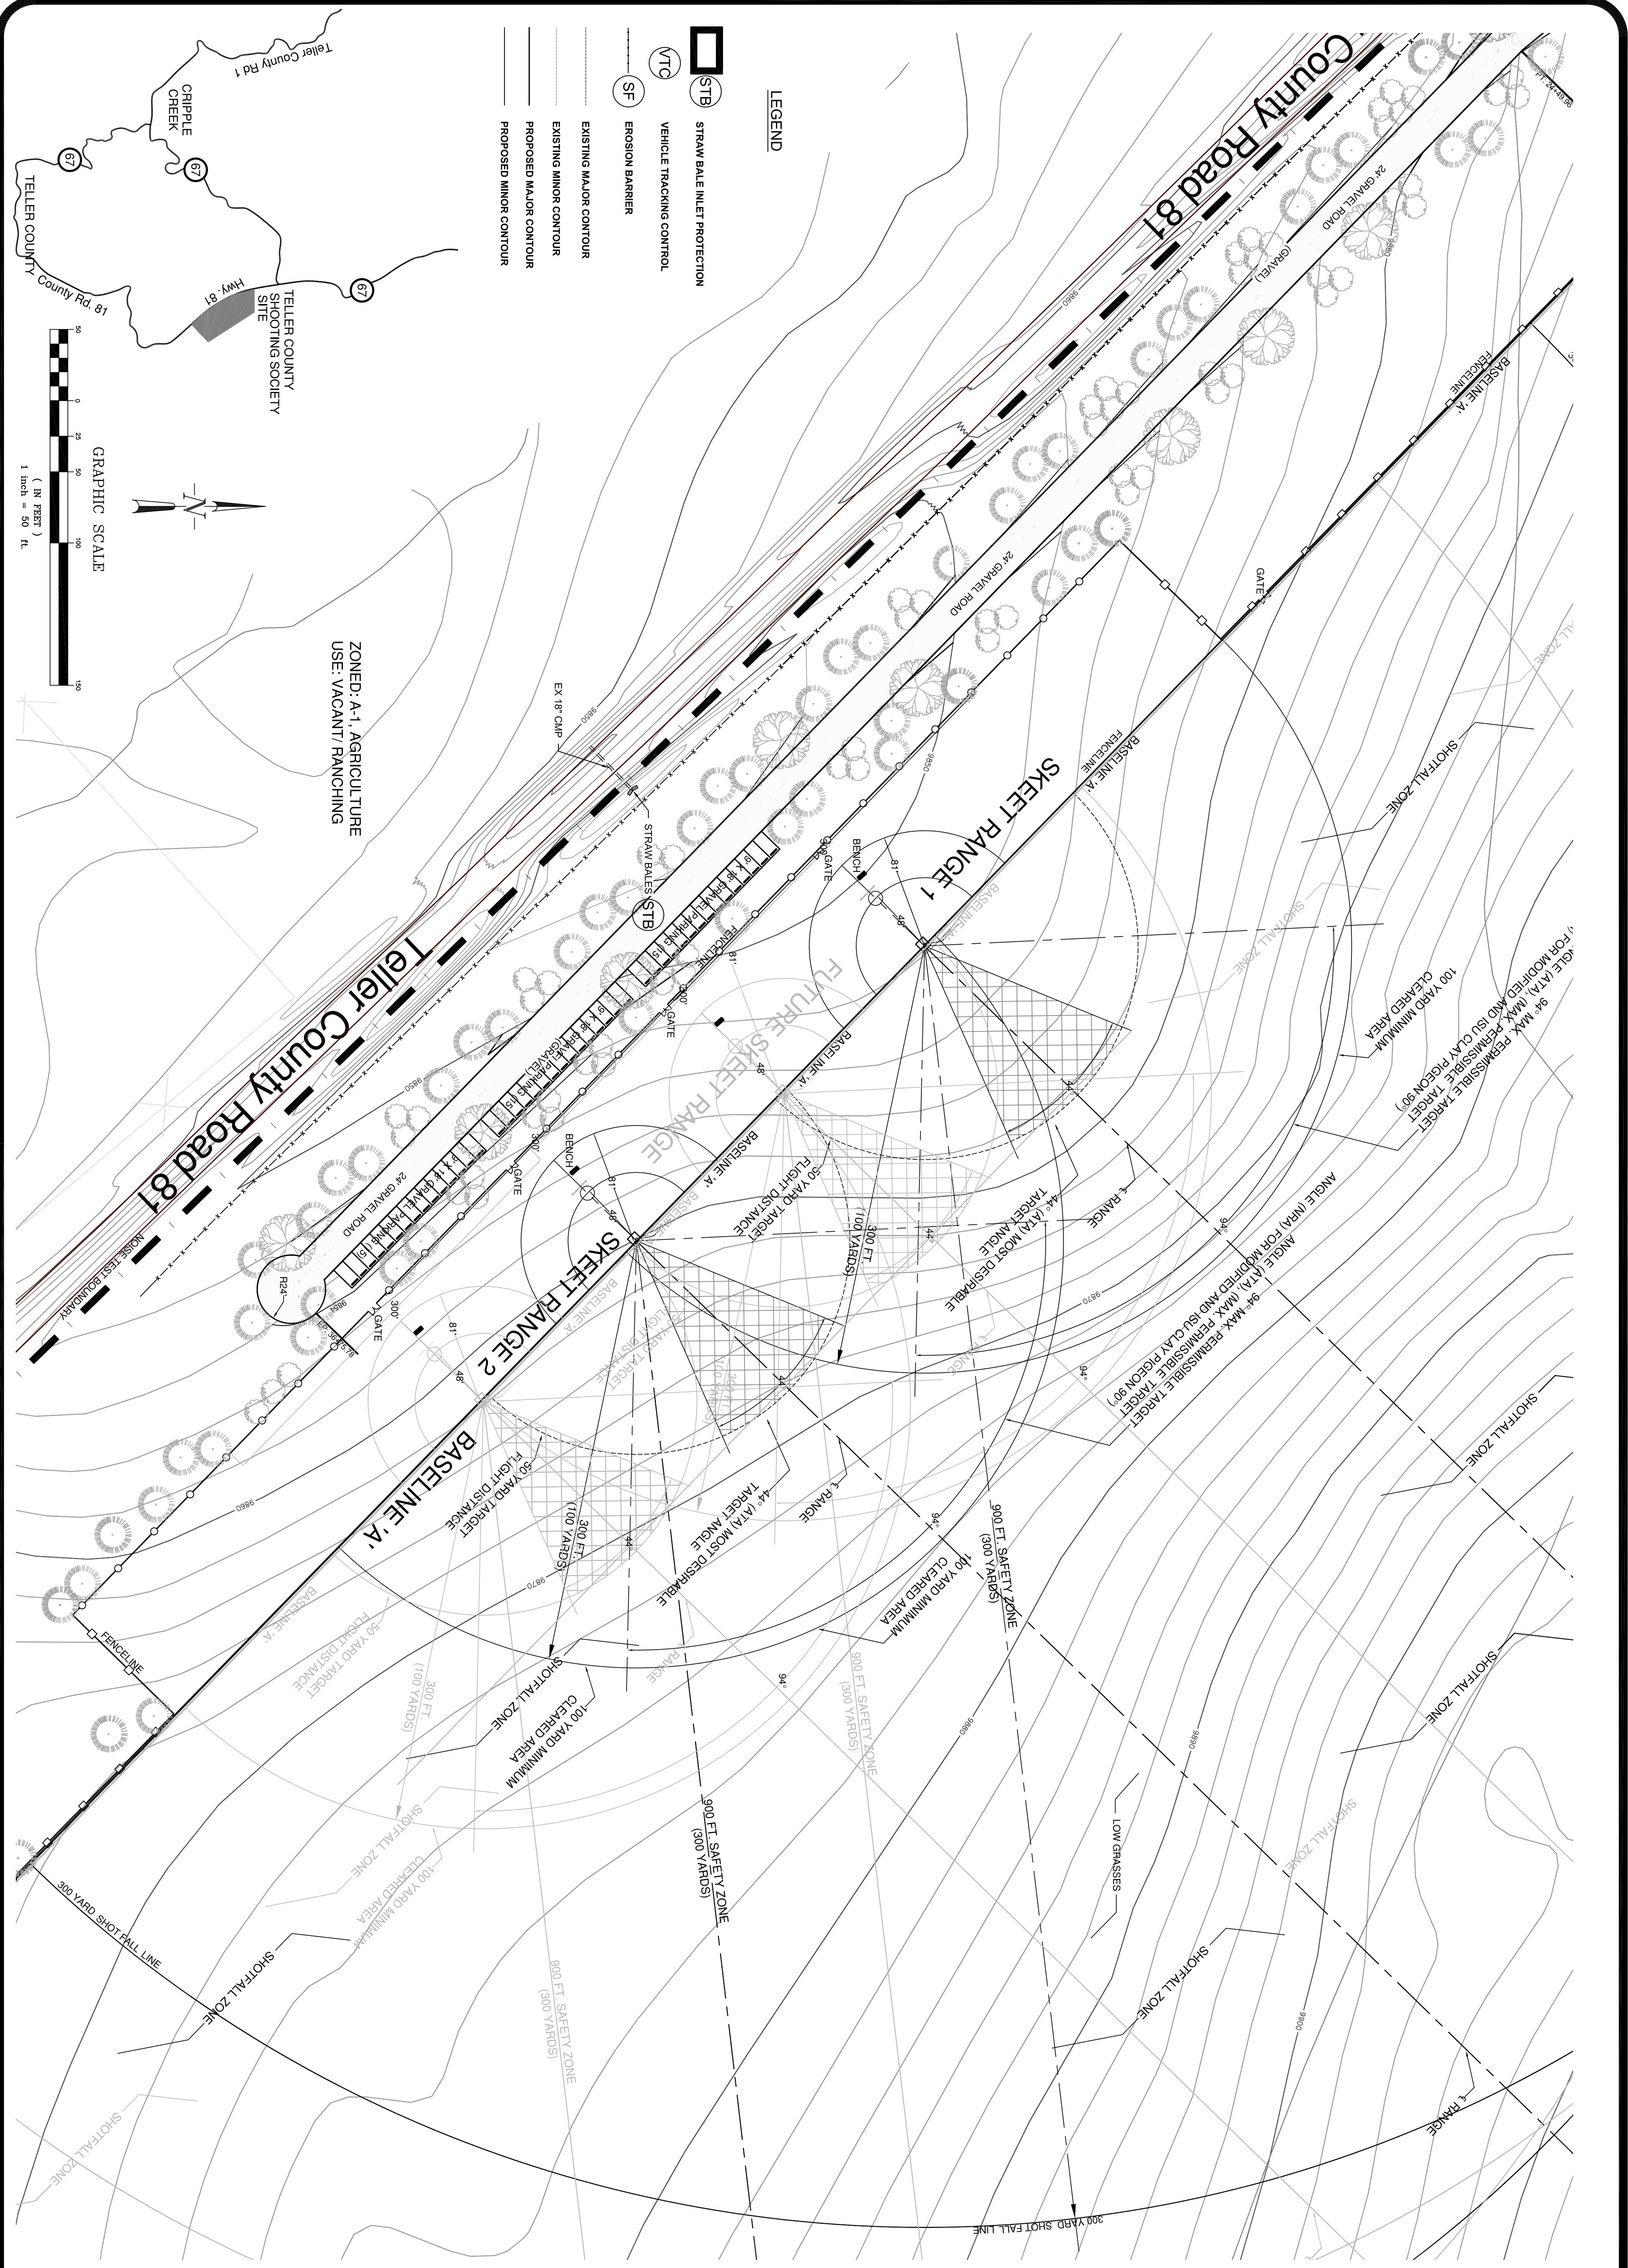


**GOLD CAMP SHOOTING SPORTS CENTER  
COUNTY ROAD 81  
TELLER COUNTY, COLORADO**

3520 Austin Bluffs Parkway  
Suite 200  
Colorado Springs, CO 80918  
(719) 266-5212  
fax: (719) 266-5341

PREPARED BY:

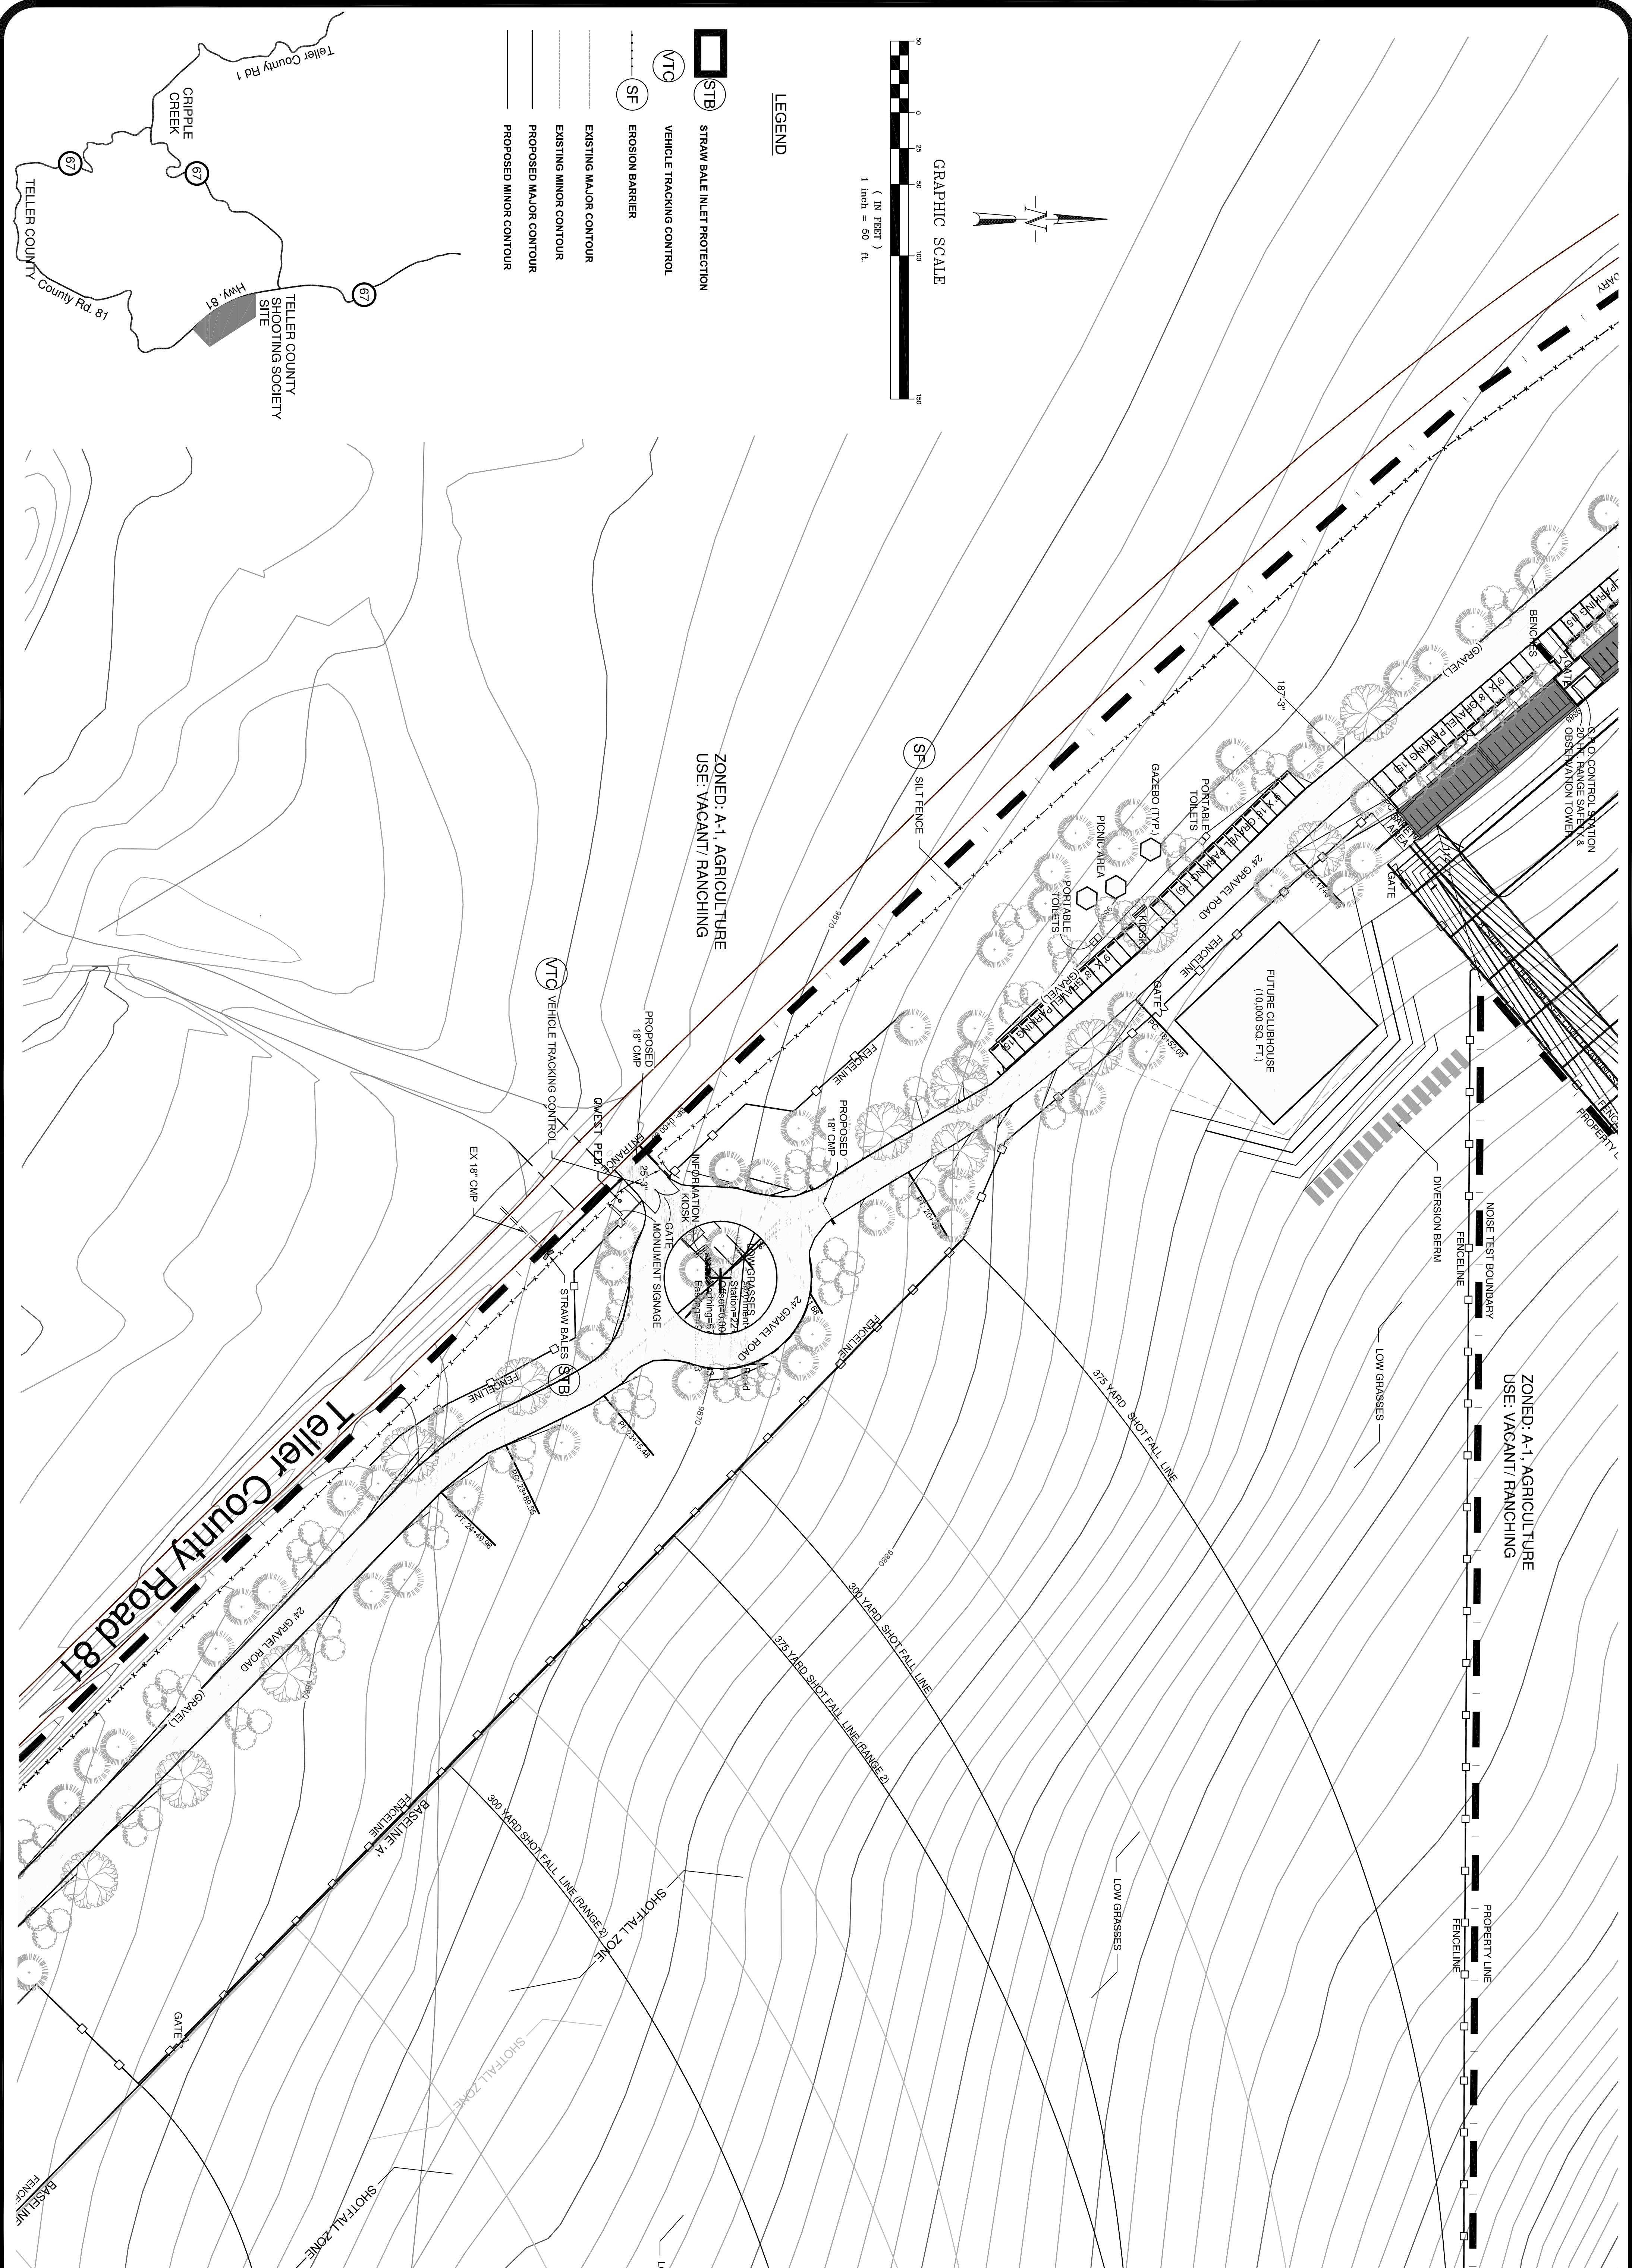

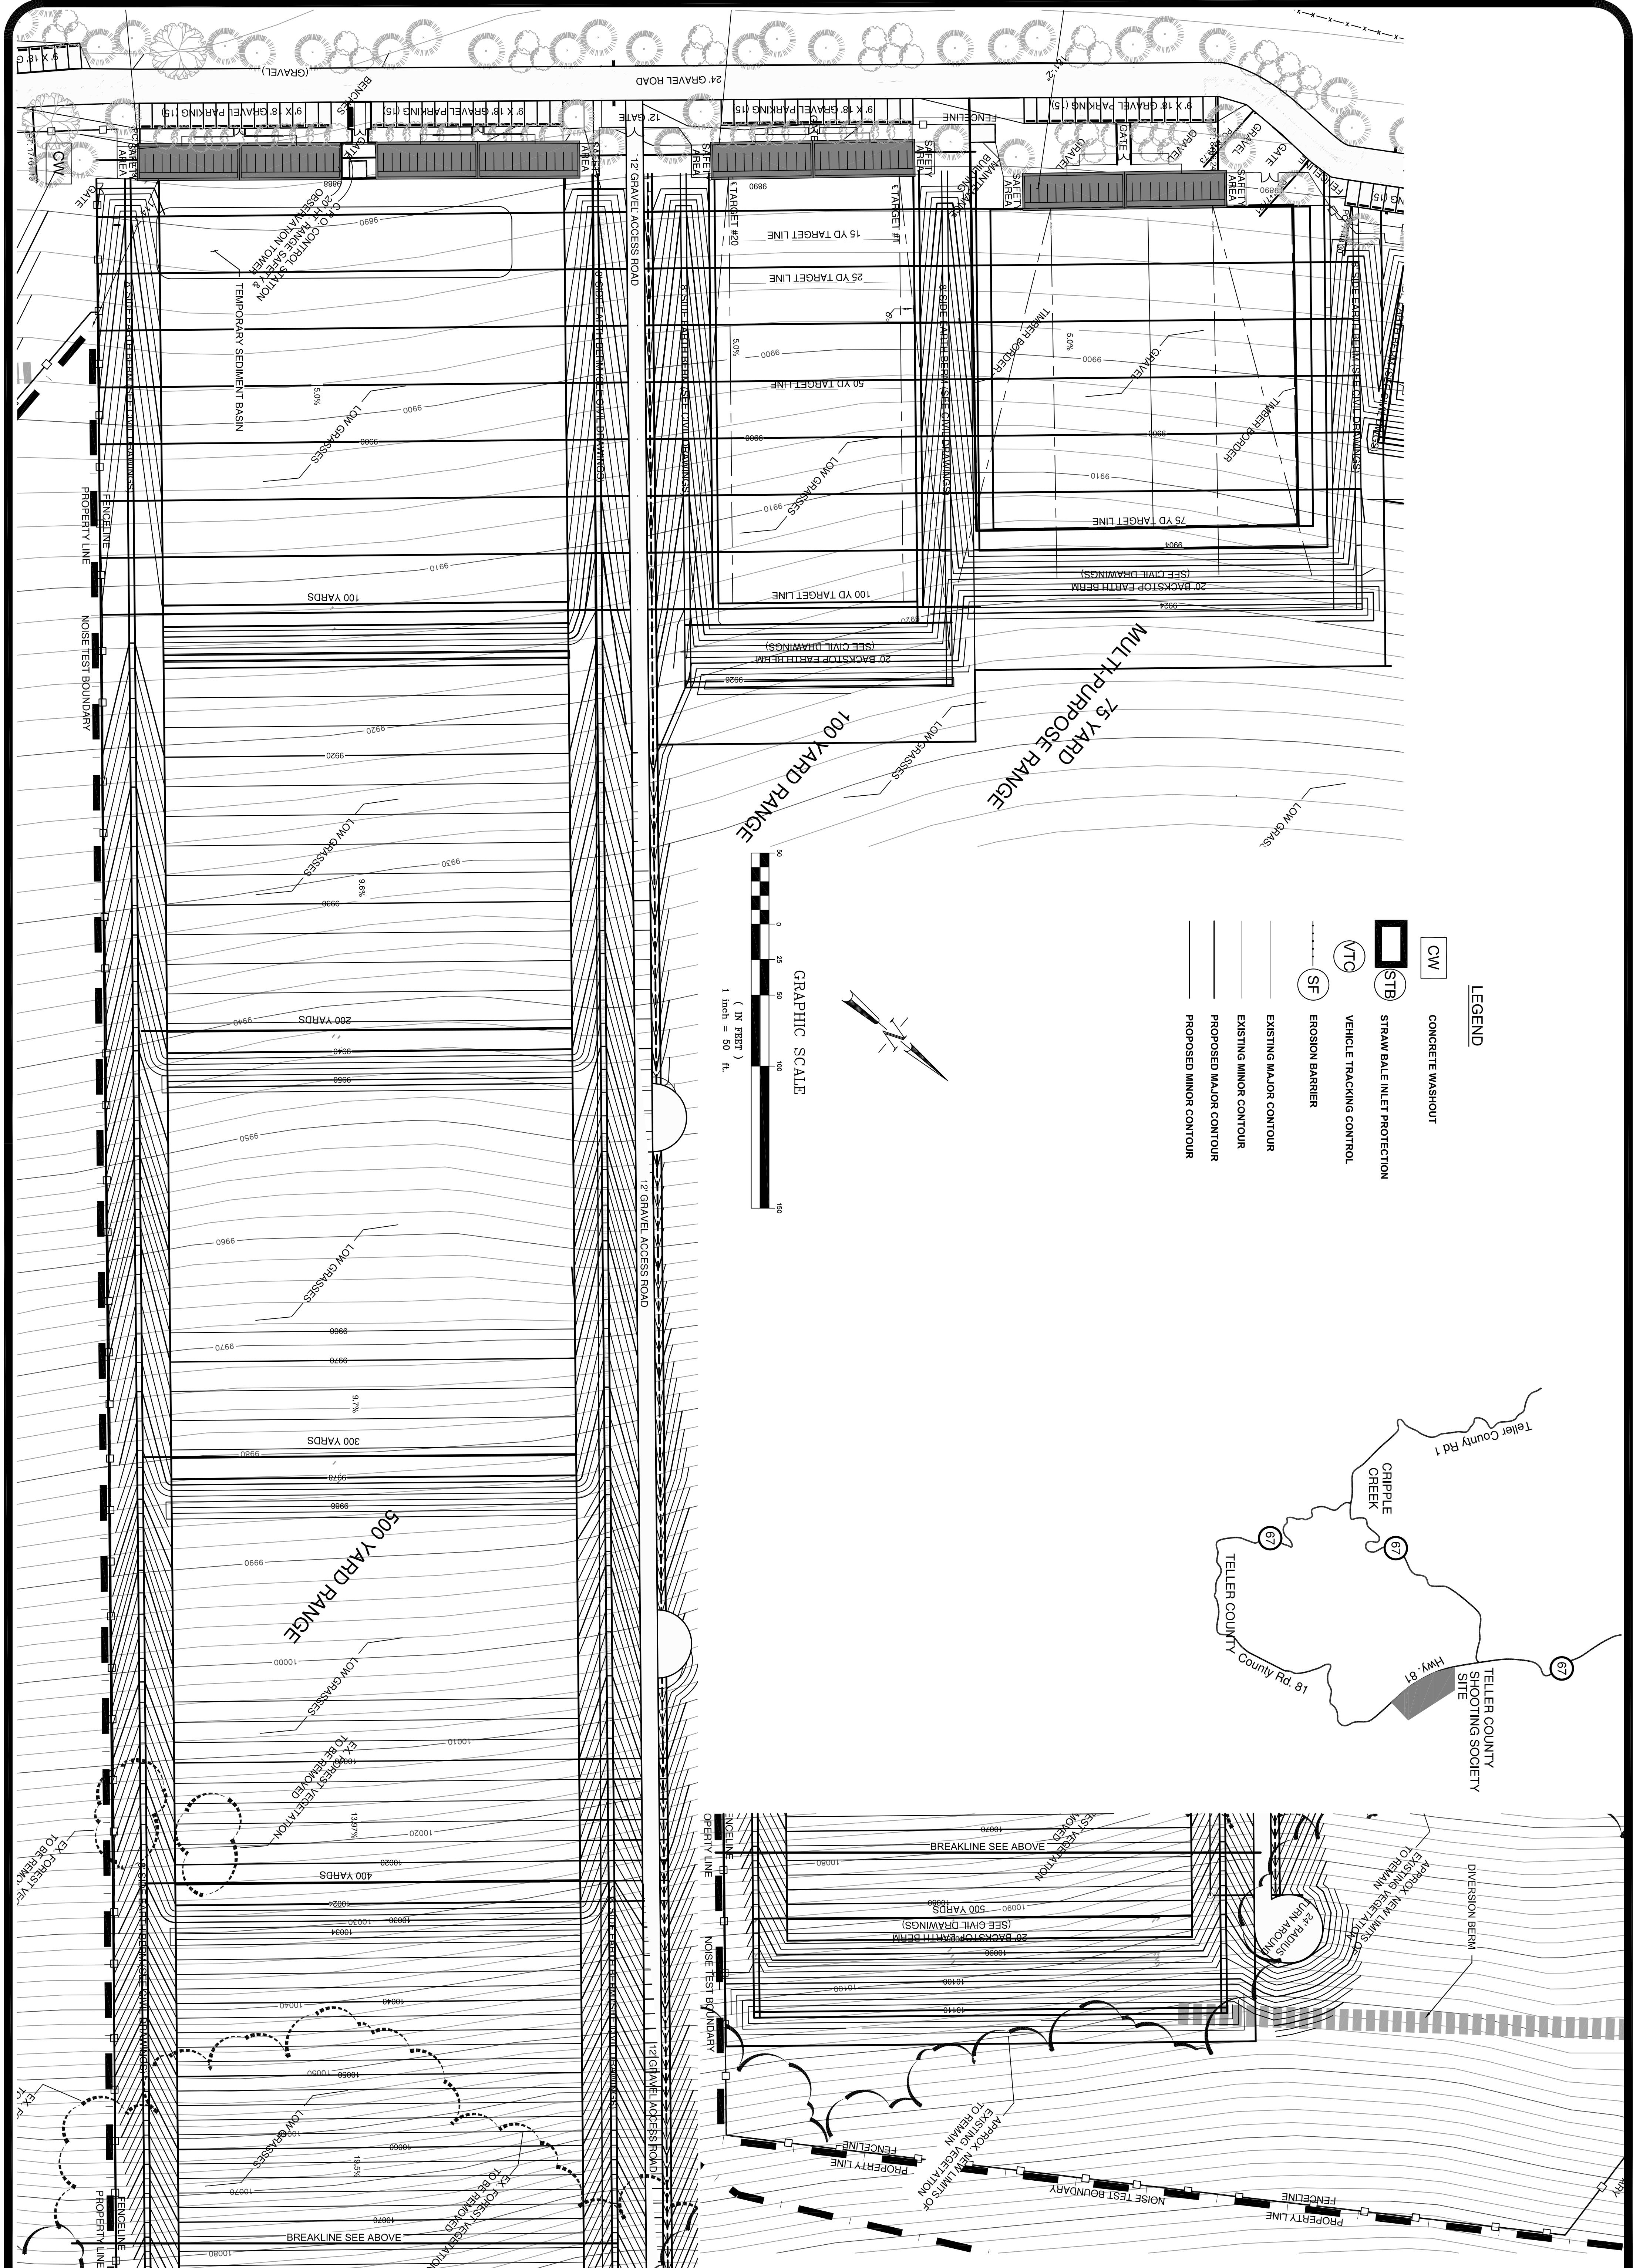

**GOLD CAMP SHOOTING SPORTS CENTER**  
**COUNTY ROAD 81**  
**TELLER COUNTY, COLORADO**  
**GRADING/EROSION CONTROL PLAN**

NO.	DATE	REVISION	BY


3520 Austin Bluffs Parkway  
 Suite 200  
 Colorado Springs, CO 80918  
 (719) 264-2522  
 Fax: (719) 598-5841



Associated Design Professionals, Inc.

PREPARED BY:

DATE: 11/19/12  
 JOB NO. 111006  
 PROJECT ENGINEER MAB  
 CAD FILE NO. BASE.DWG  
 DRAWN BY JRH  
 DESIGNED BY JRH  
 PROJECT MANAGER MAB  
 SCALE: HORIZ. 1" = 100'  
 VERT. \_\_\_\_\_

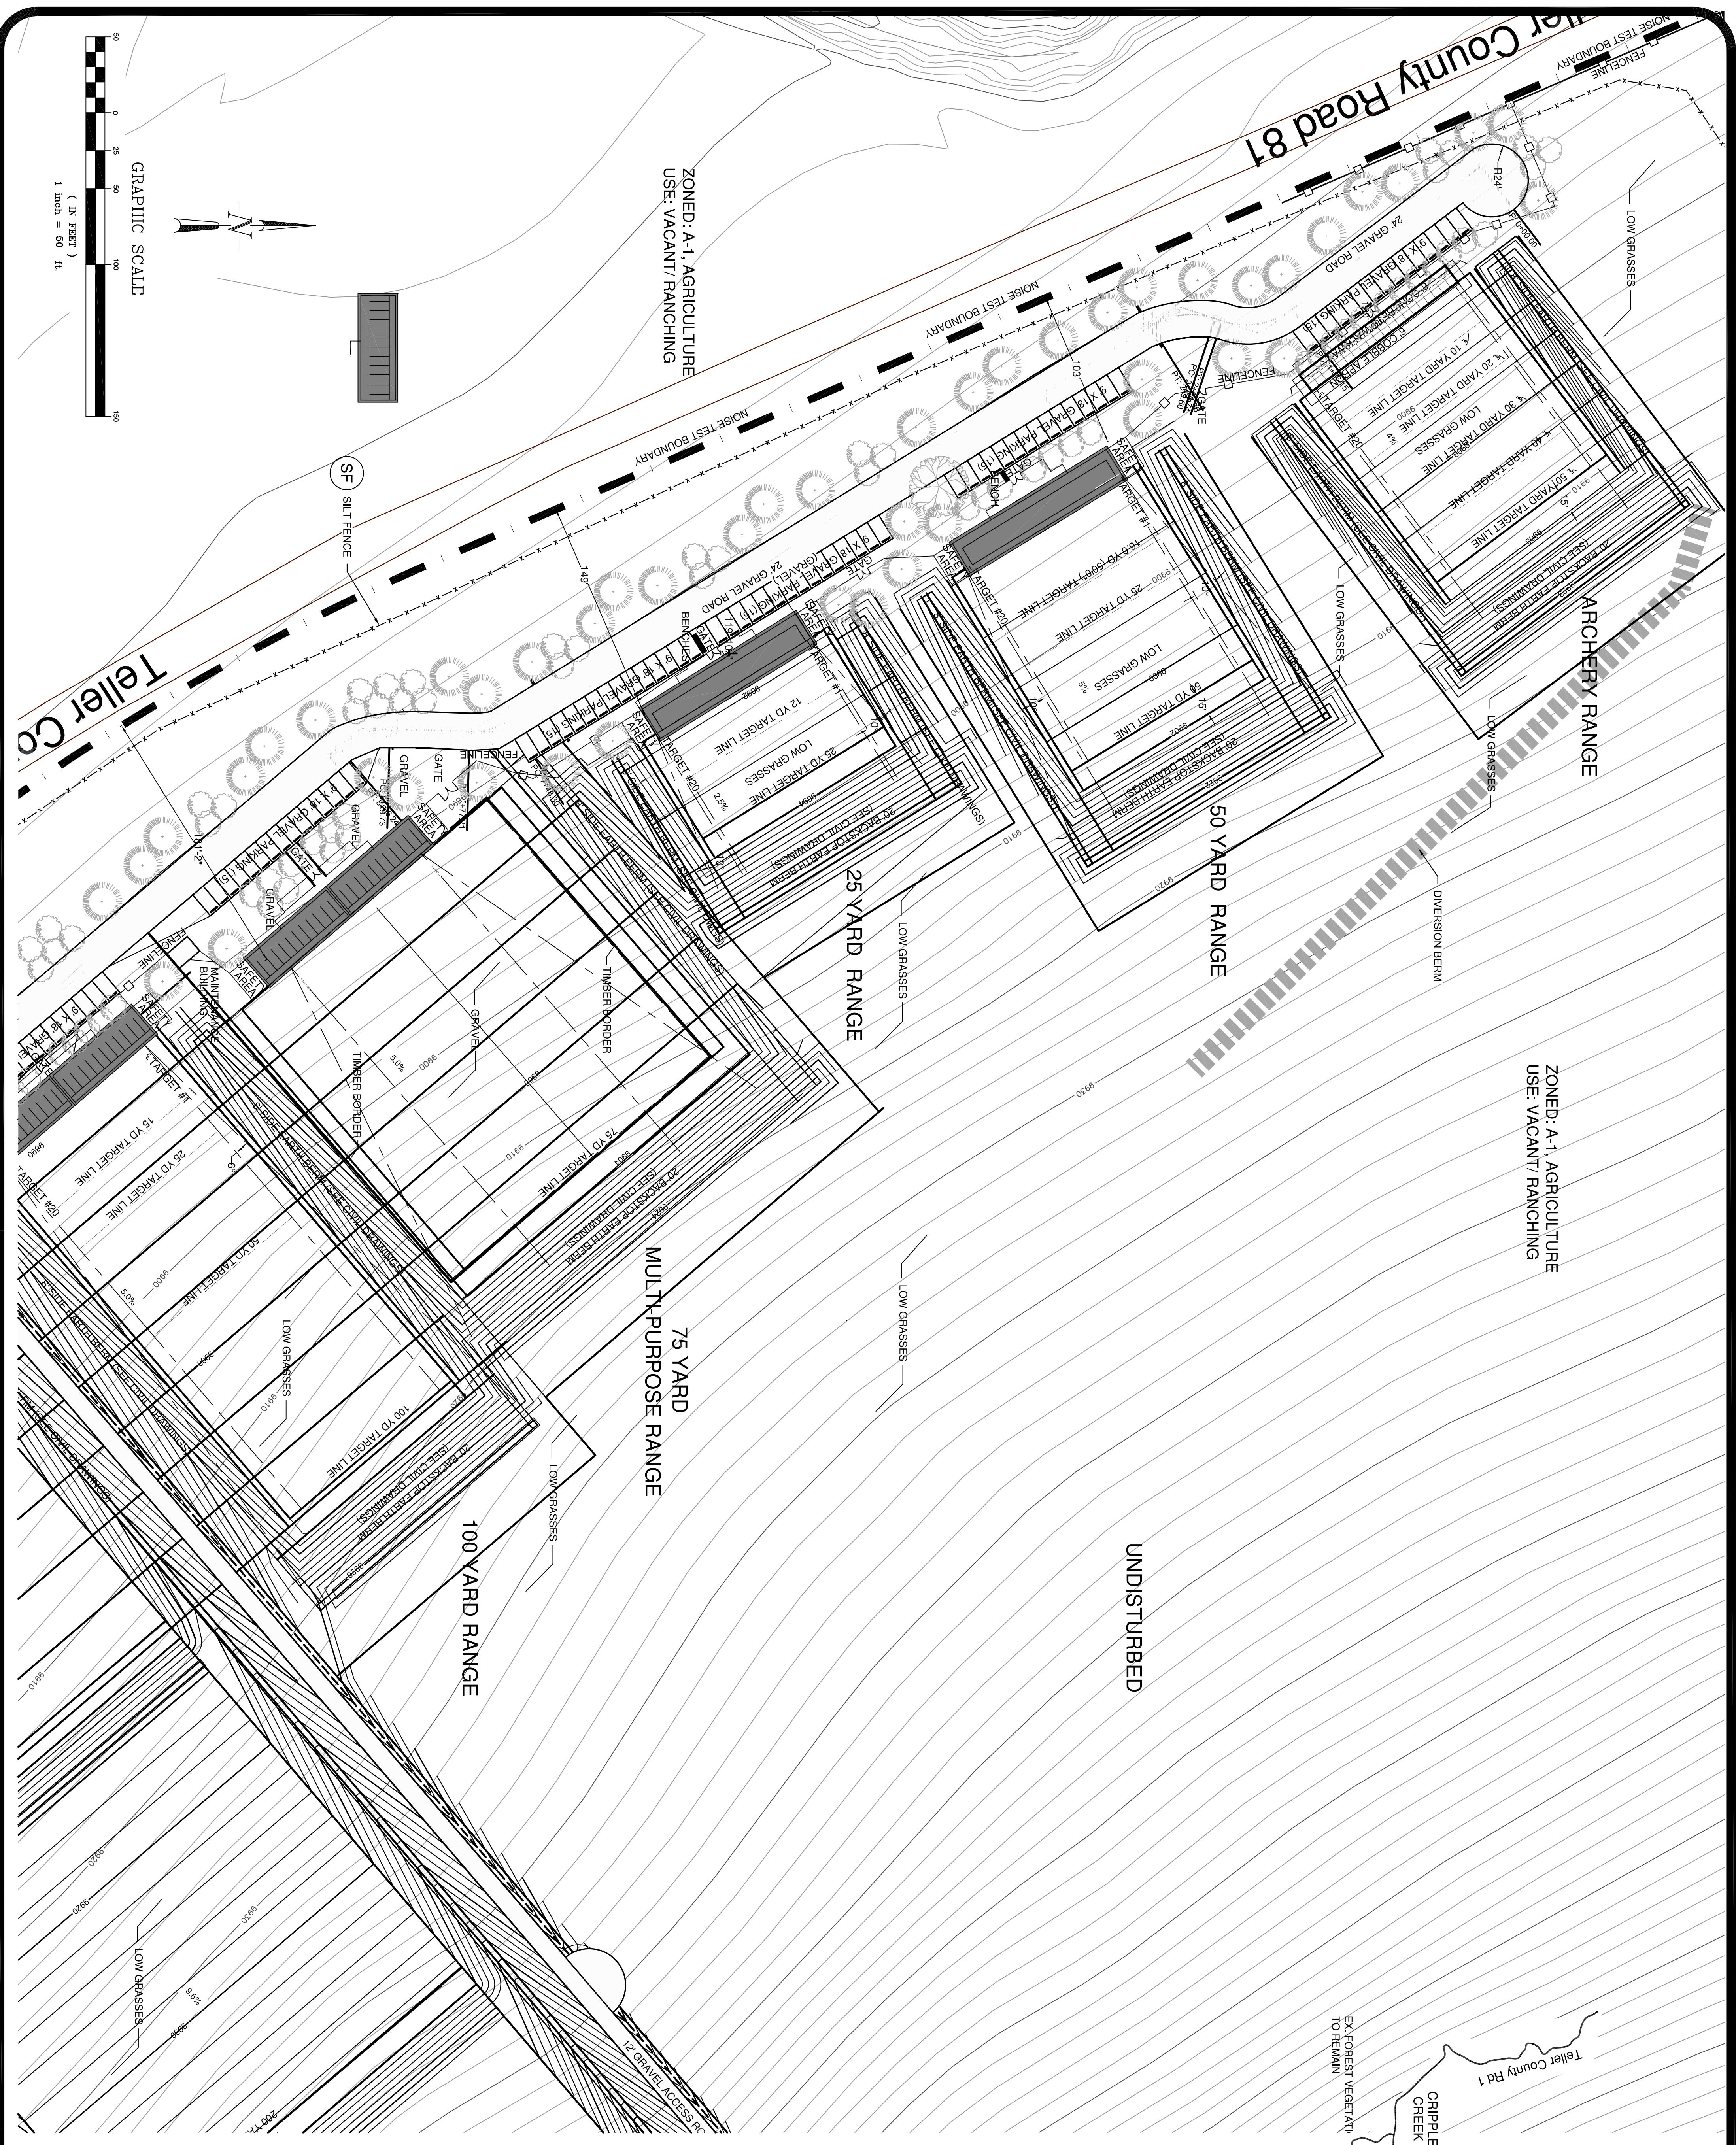

**GOLD CAMP SHOOTING SPORTS CENTER  
COUNTY ROAD 81  
TELLER COUNTY, COLORADO**


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## Associated Design Professionals, Inc.

PREPARED BY:	DATE: 11/19/12	DESIGNED BY JRH
	JOB NO. 111006	PROJECT ENGINEER MAB
	CAD FILE NO. BASE.DWG	PROJECT MANAGER MAB
	DRAWN BY JRH	SCALE: HORZ. <u>1" = 100'</u> VERT. <u>                  </u>






*Corporate Office*  
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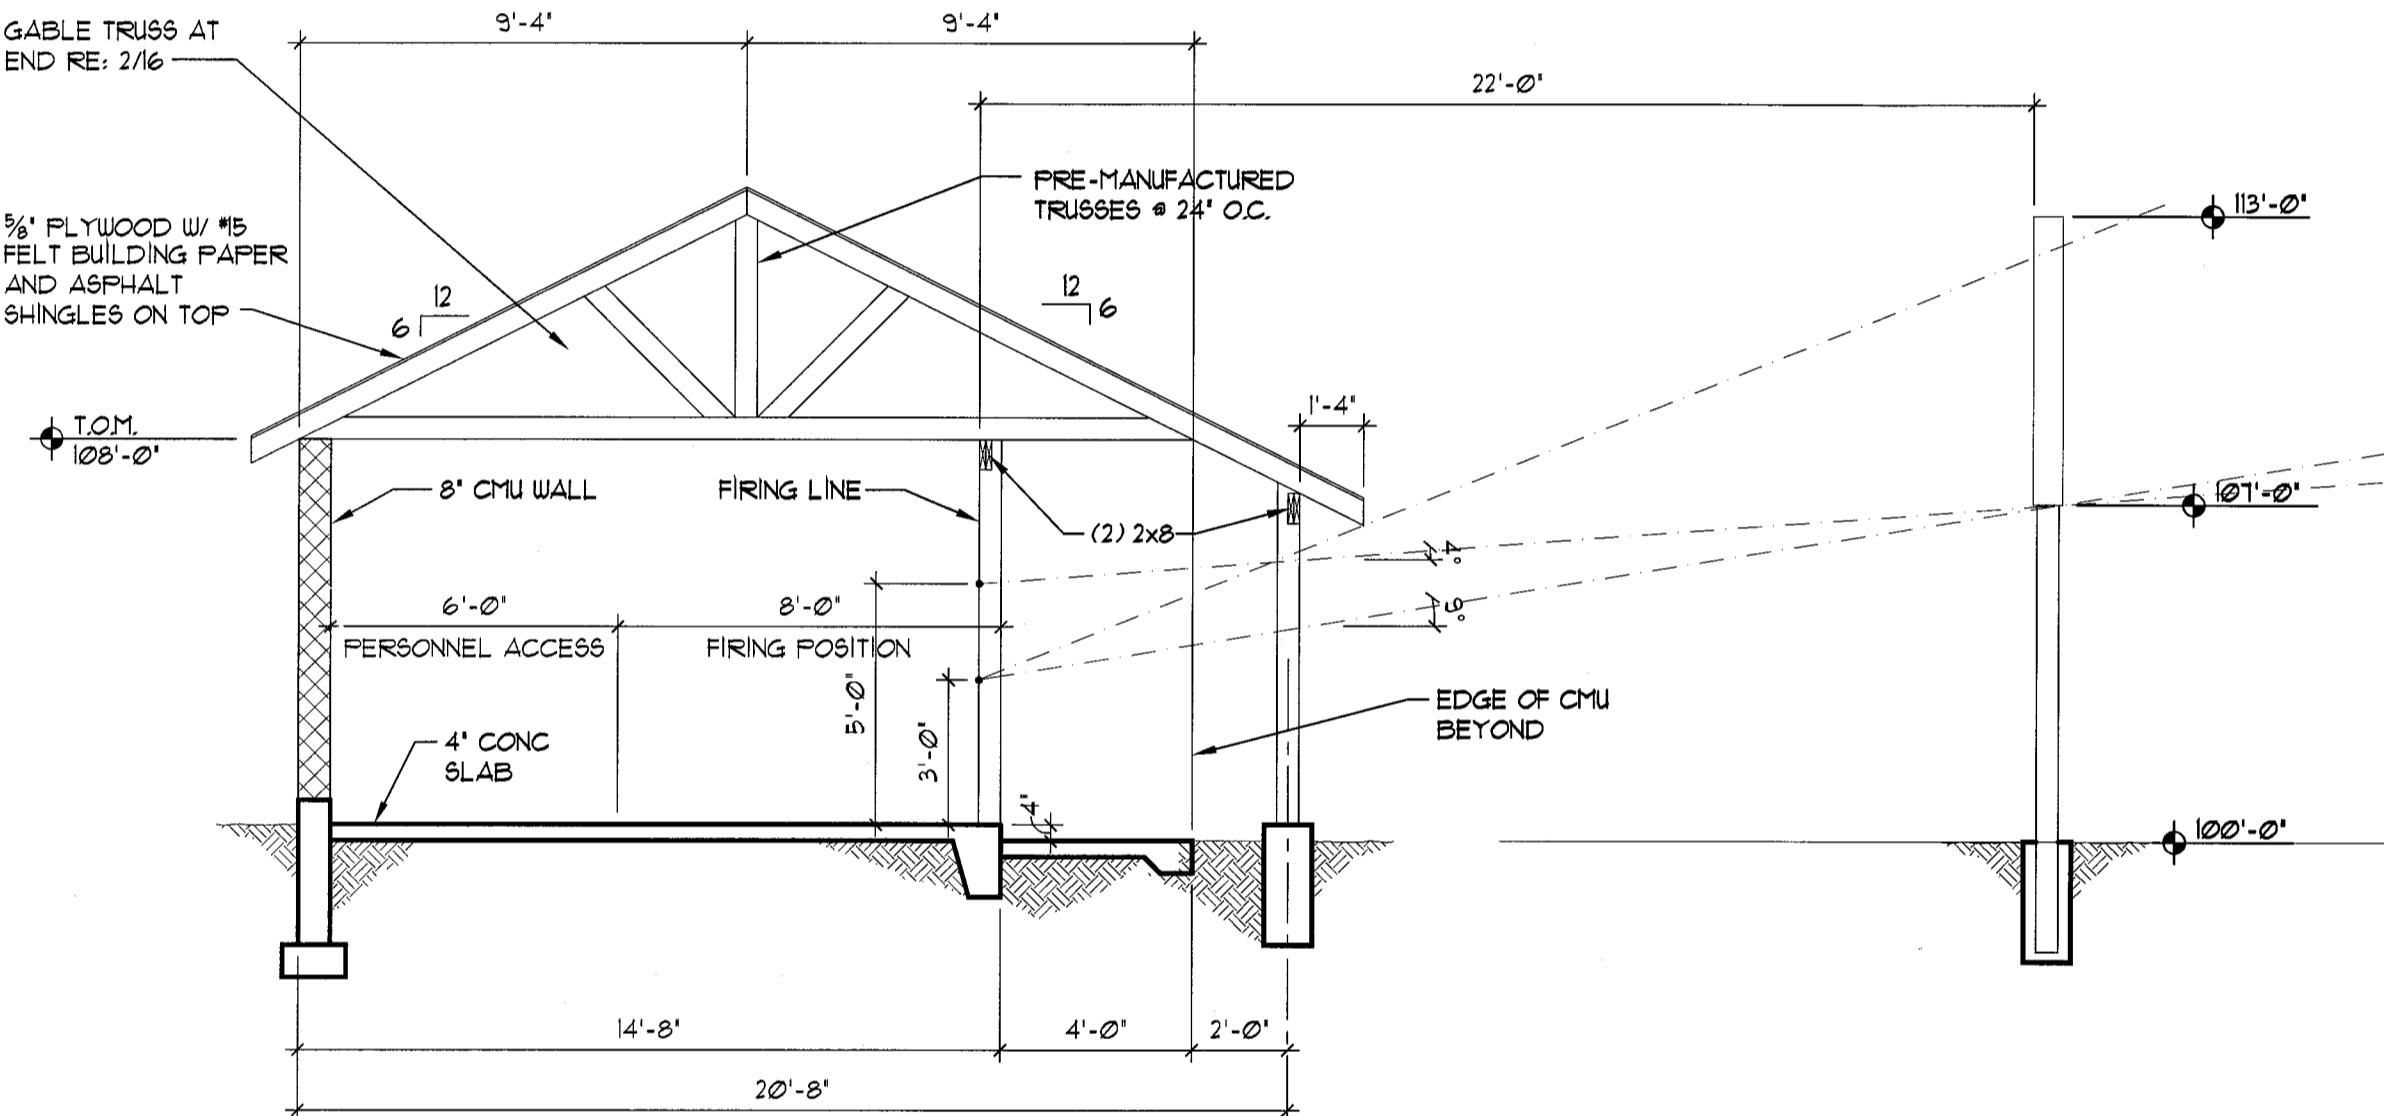
## RANGE SECTION

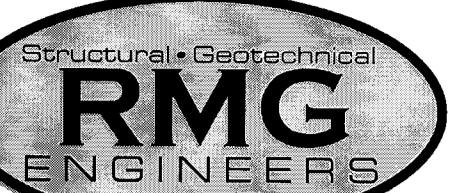SCALE: 1/8" = 1'-0"




## RANGE SECTION

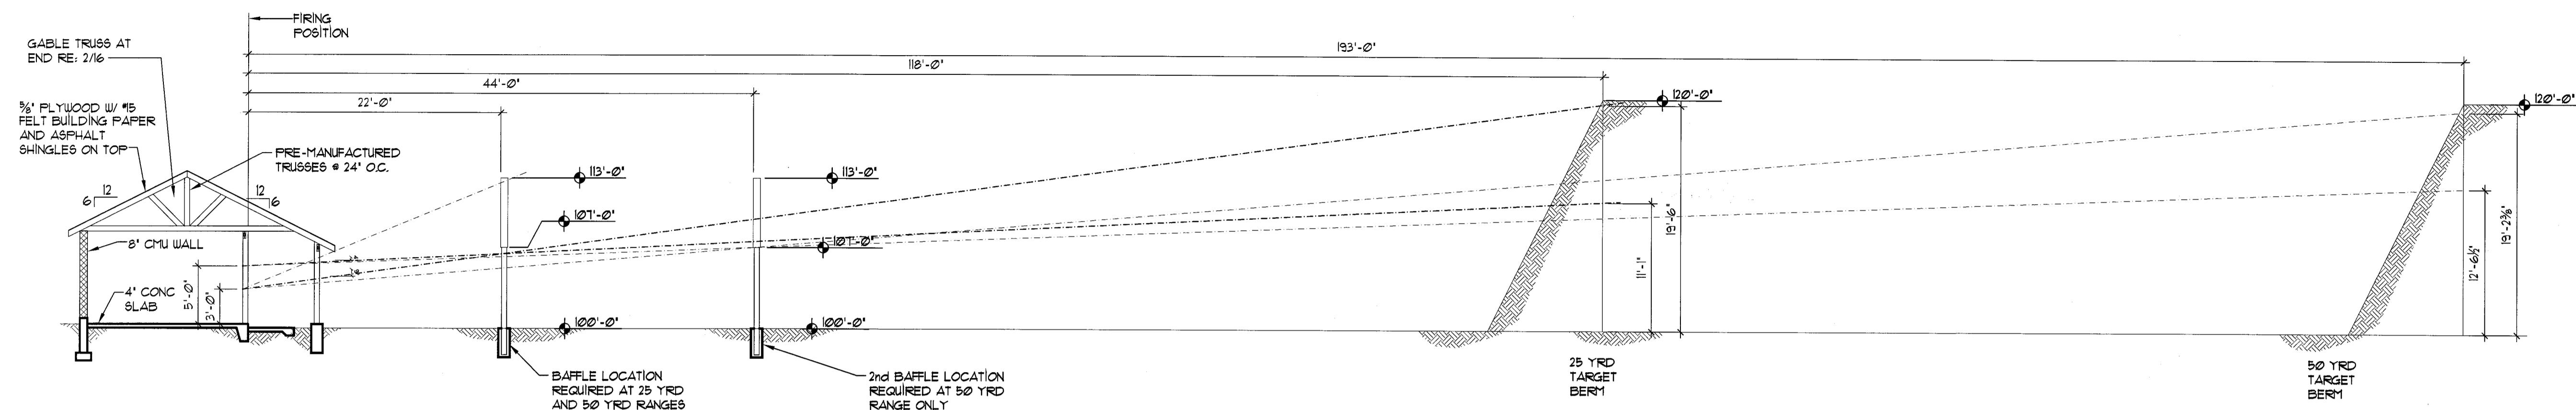SCALE: 1/8" = 1'-0"






# FIRING LINE STRUCTURE SECTION

— SCALE: 1/4" = 1'-0" —

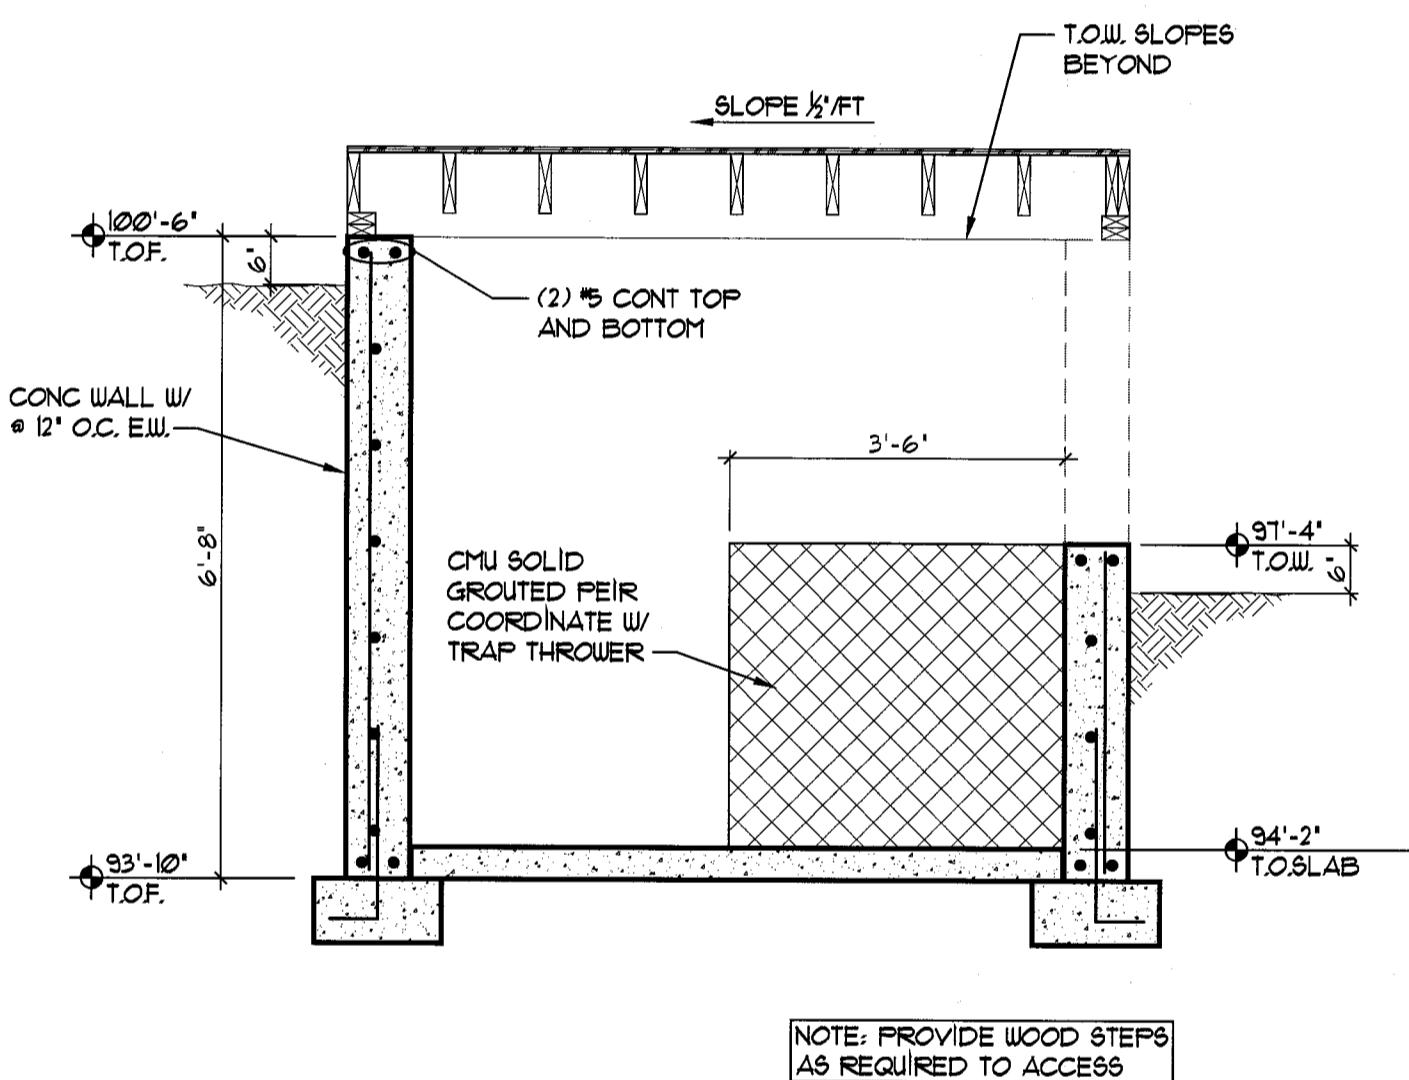

**1** **TRAP HOUSE SECTION**  
**14** **SCALE: 1/2' = 1'-0"**

**SKEET HOUSE WALL  
FOUNDATION DETAIL**

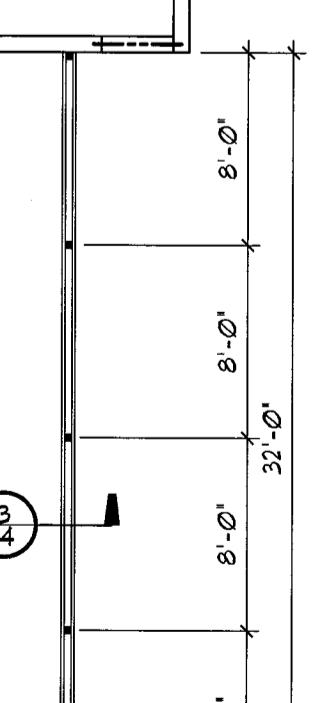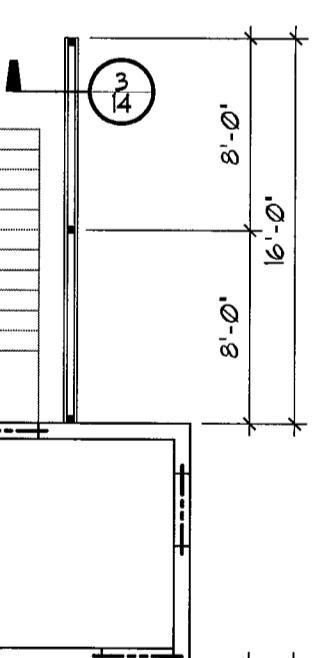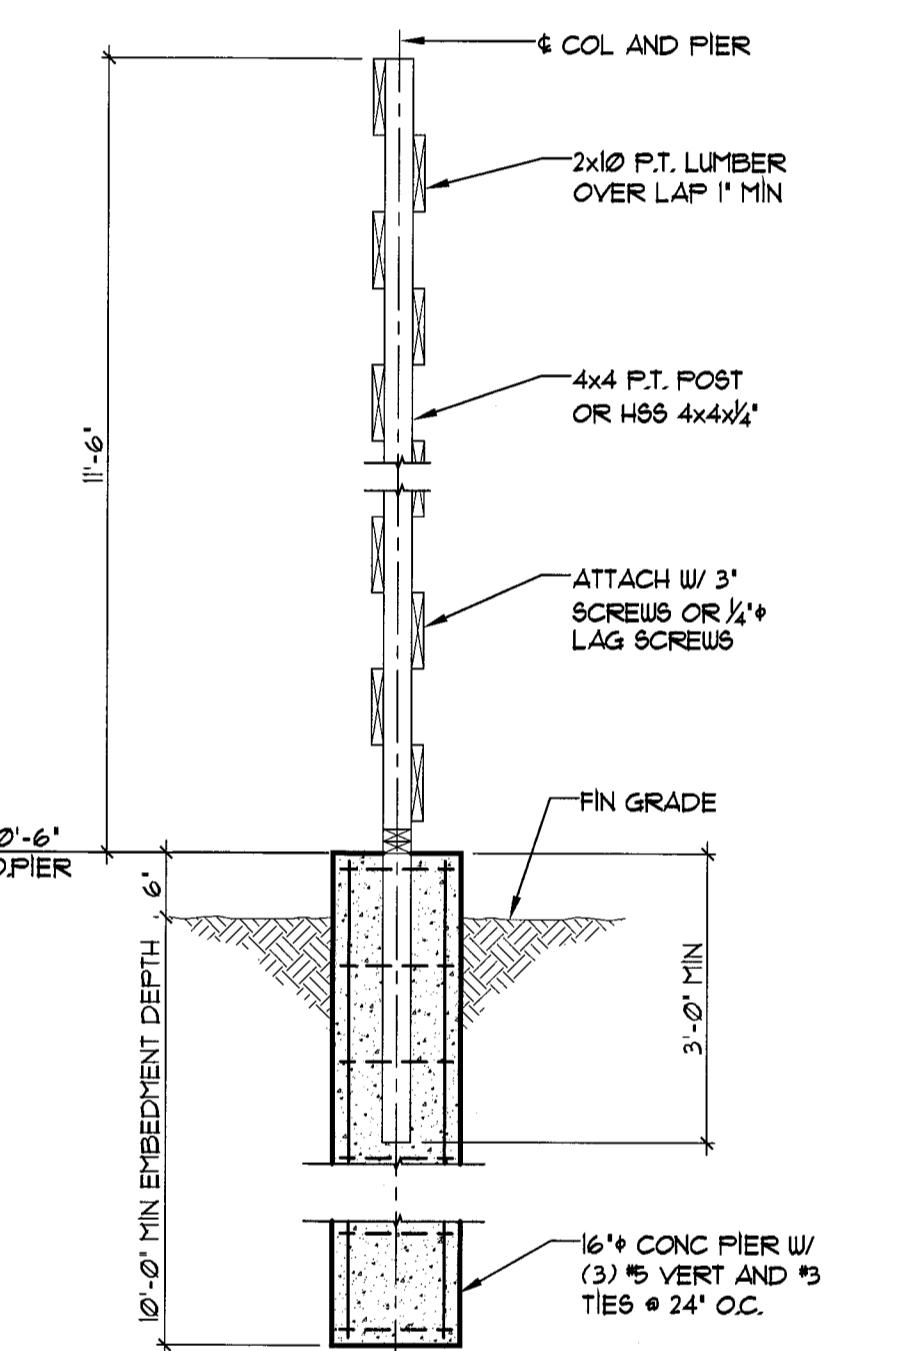

SEE 13 FOR  
PLAN NOTES

10'-0"

10'-0"

2 1/4

LUS26-2 HANG  
LEDGER W/ (2)  
SCREWS AND  
NAILS @ 24' O.C.

2x8 @ 16' O.C.

1/8" = 1'-0"

SEE 13 FOR  
PLAN NOTES

10'-0"

2x6  
LAG

116'-0"

18/6

7/16


2x8 @ 24" O.C.

T.O.M.  
(116'-0")

NORTH

**SKEET HOUSE  
ROOF FRAMING PLAN**

SCALE: 1/8" = 1'-0"

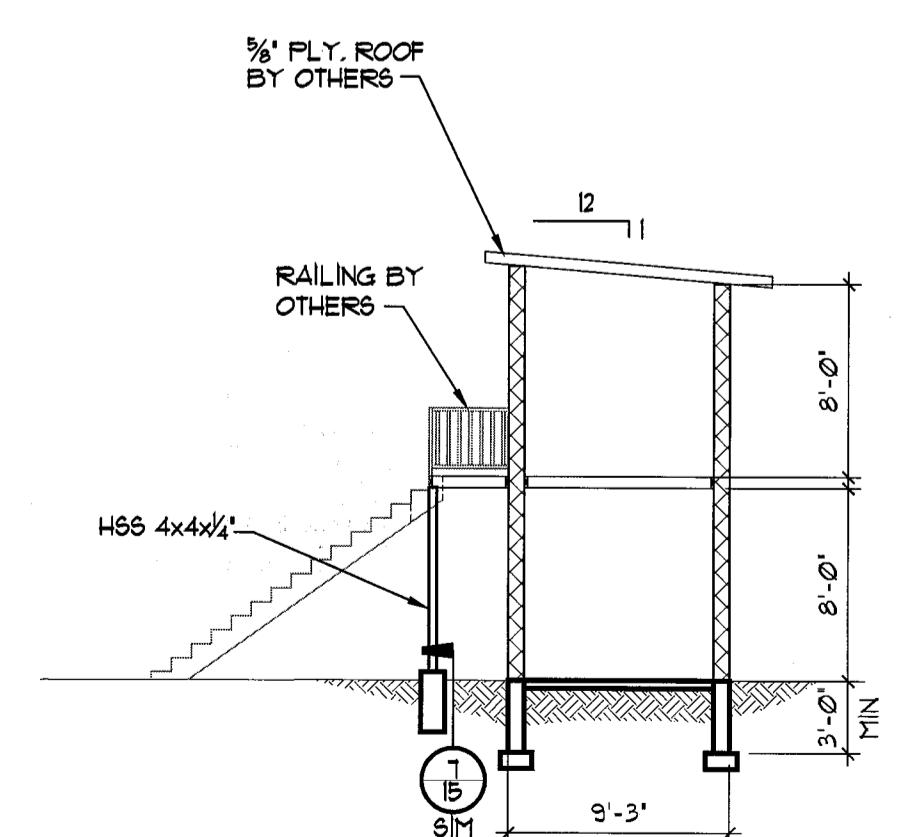

2 14 HI-LOW SKEET HOUSE SECTION SCALE: 1/8" = 1'-0"

SEE 13 FOR  
PLAN NOTES



NORTH

# SET HOUSE WALL PLAN VIEW

---

SCALE: 1/8" = 1'-0"

ENGINEER:	MW
DRAWN BY:	CL
CHECKED BY:	MW
PRINTING:	DATE:
SUBMITTAL	11.05.12

# FOUNDATION FRAMING PLANS SECTIONS AND DETAILS

SHEET No. 14 OF 1



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Woodland Park Office:


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Pueblo Office:

(719) 544-7750



## GOLD CAMP SHOOTING SPORTS CENTER CR 81


TELLER COUNTY, COLORADO  
TELLER COUNTY SHOOTING SOCIETY

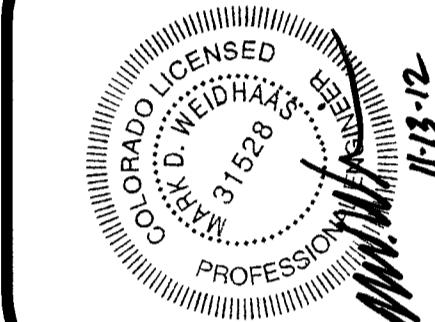ENGINEER: MW  
DRAWN BY: CL  
CHECKED BY: MW  
PRINTING: DATE:  
SUBMITTAL 11-05-12

REVISION: DATE:  
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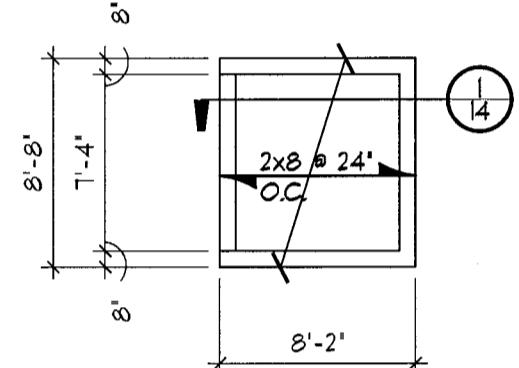
FOUNDATION AND ROOF FRAMING PLANS  
SHEET No. 13

13 OF 16  
JOB No. 131963

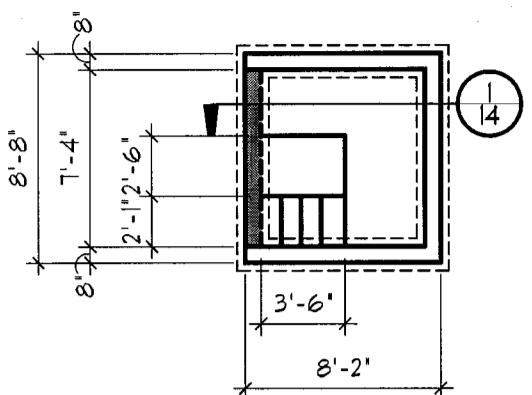

**TRAP HOUSE FOUNDATION PLAN NORTH**


SCALE: 1/8" = 1'-0"



**NORTH**


**TRAP HOUSE ROOF FRAMING PLAN**

SCALE: 1/8" = 1'-0"

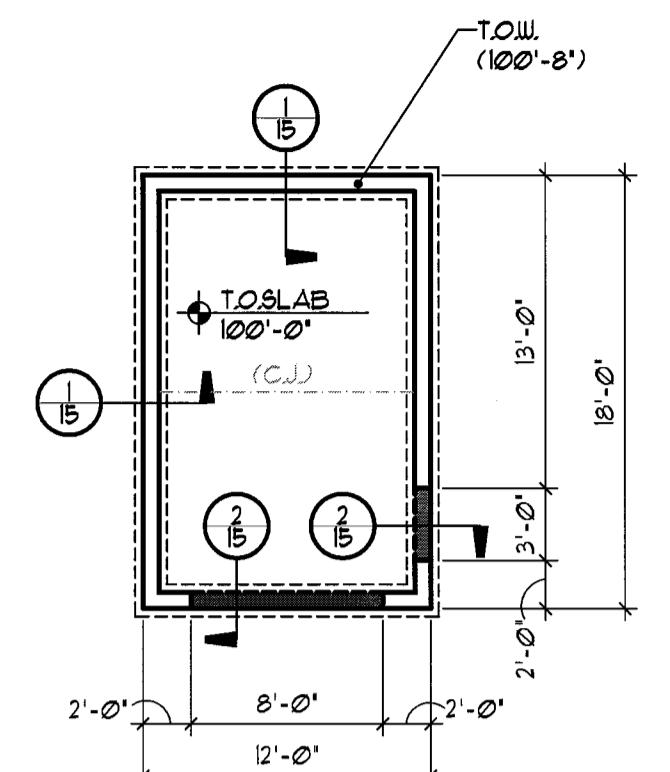


**STORAGE SHED FOUNDATION PLAN**

SCALE: 1/8" = 1'-0"

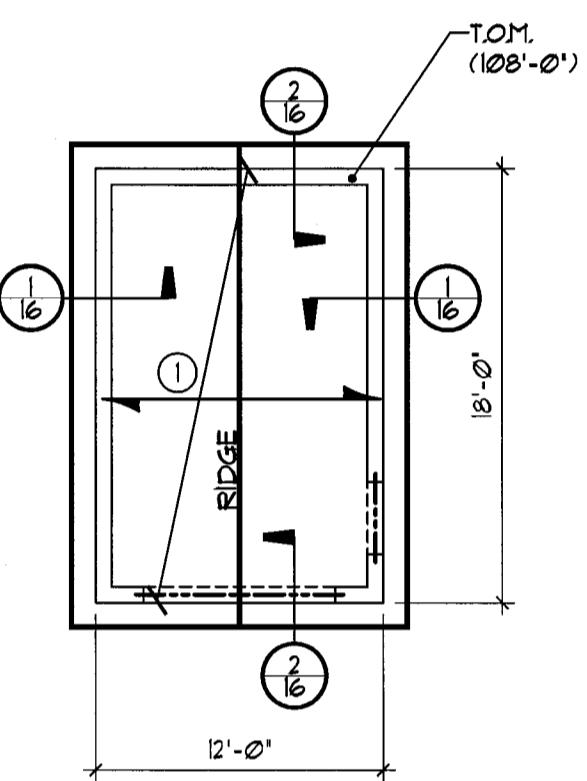

**STORAGE SHED ROOF FRAMING PLAN**

SCALE: 1/8" = 1'-0"

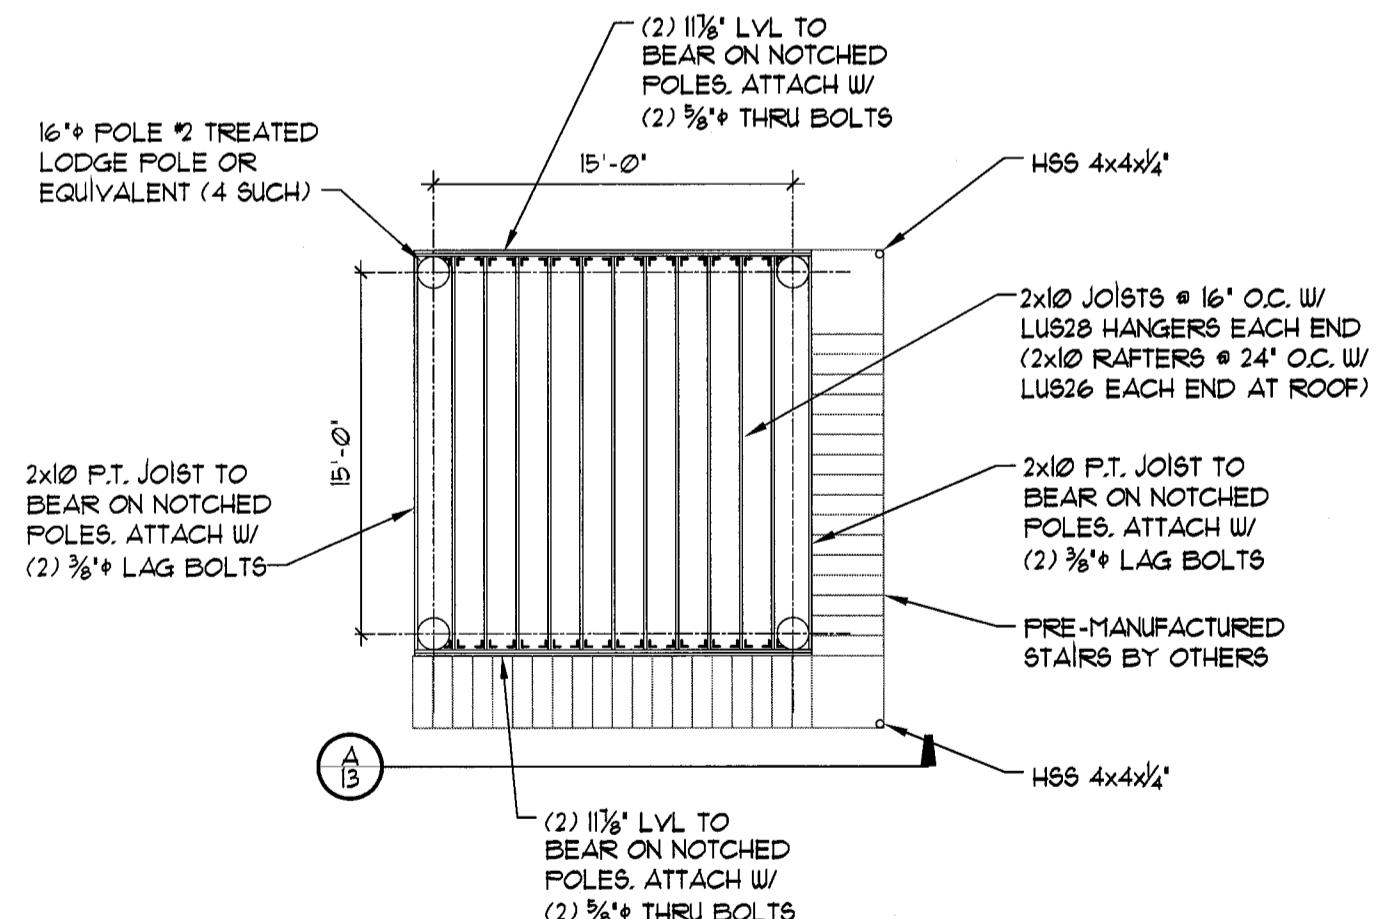

**RANGE CONTROL/SAFETY OBSERVATION TOWER FLOOR/ROOF FRAMING PLAN**


**NORTH**

SCALE: 1/8" = 1'-0"



**RANGE CONTROL/SAFETY OBSERVATION TOWER SECTION**

SCALE: 1/8" = 1'-0"

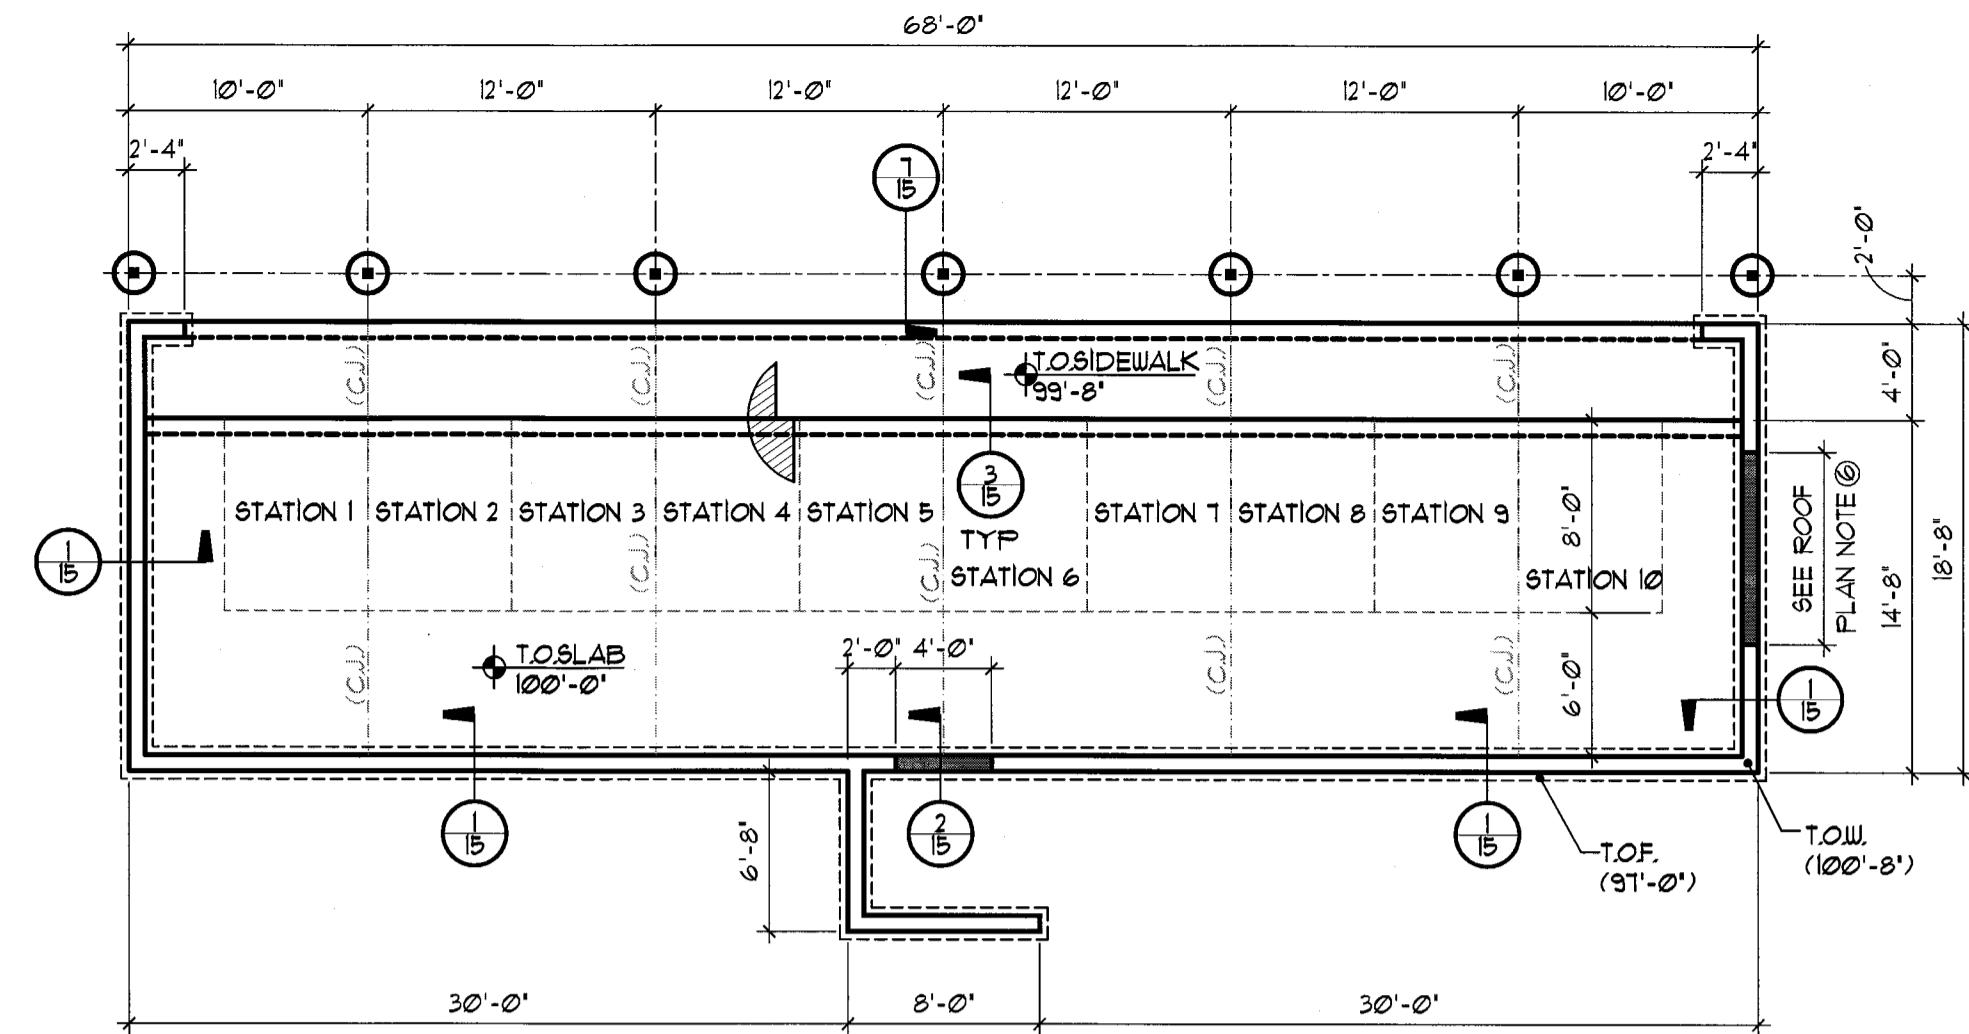


**10 STATION FIRING LINE STRUCTURE FOUNDATION PLAN**

**NORTH**

SCALE: 1/8" = 1'-0"

**FOUNDATION PLAN NOTES**

1. FLOOR IS 4" CONCRETE SLAB ON GRADE REINFORCED WITH CELLULOSE FIBER MESH REINFORCING
2. ELEVATION TOP OF SLAB = 100'-0", EXCEPT AS NOTED THUS: T.O.U. (XX'-X'). T.O.U. ELEVATIONS SHALL MAINTAIN A MINIMUM OF 6' ABOVE FINISH GRADE
3. ELEVATION TOP OF CONCRETE FOUNDATION WALLS = 100'-0" EXCEPT AS NOTED THUS: T.O.U. (XX'-X'). T.O.U. ELEVATIONS SHALL MAINTAIN A MINIMUM OF 6' ABOVE FINISH GRADE
4. ELEVATION TOP OF EXTERIOR FOOTINGS = 91'-0" EXCEPT AS NOTED THUS: T.O.F. (XX'-X').
5. ALL FOOTINGS ARE CENTERED BELOW COLUMNS OR WALLS UNO
6. ALL CONTINUOUS FOOTINGS ARE 1'-0" DEEP AND 1'-6" WIDE UNO
7. FOR TYPICAL SLAB CONTROL JOINT DETAIL RE: 1/4" ALL CONTROL JOINTS (C.J.) TO BE VERIFIED BY CONTRACTOR
8. FOR CORNER REINFORCING IN STEM WALLS RE: 5/14
- 9.

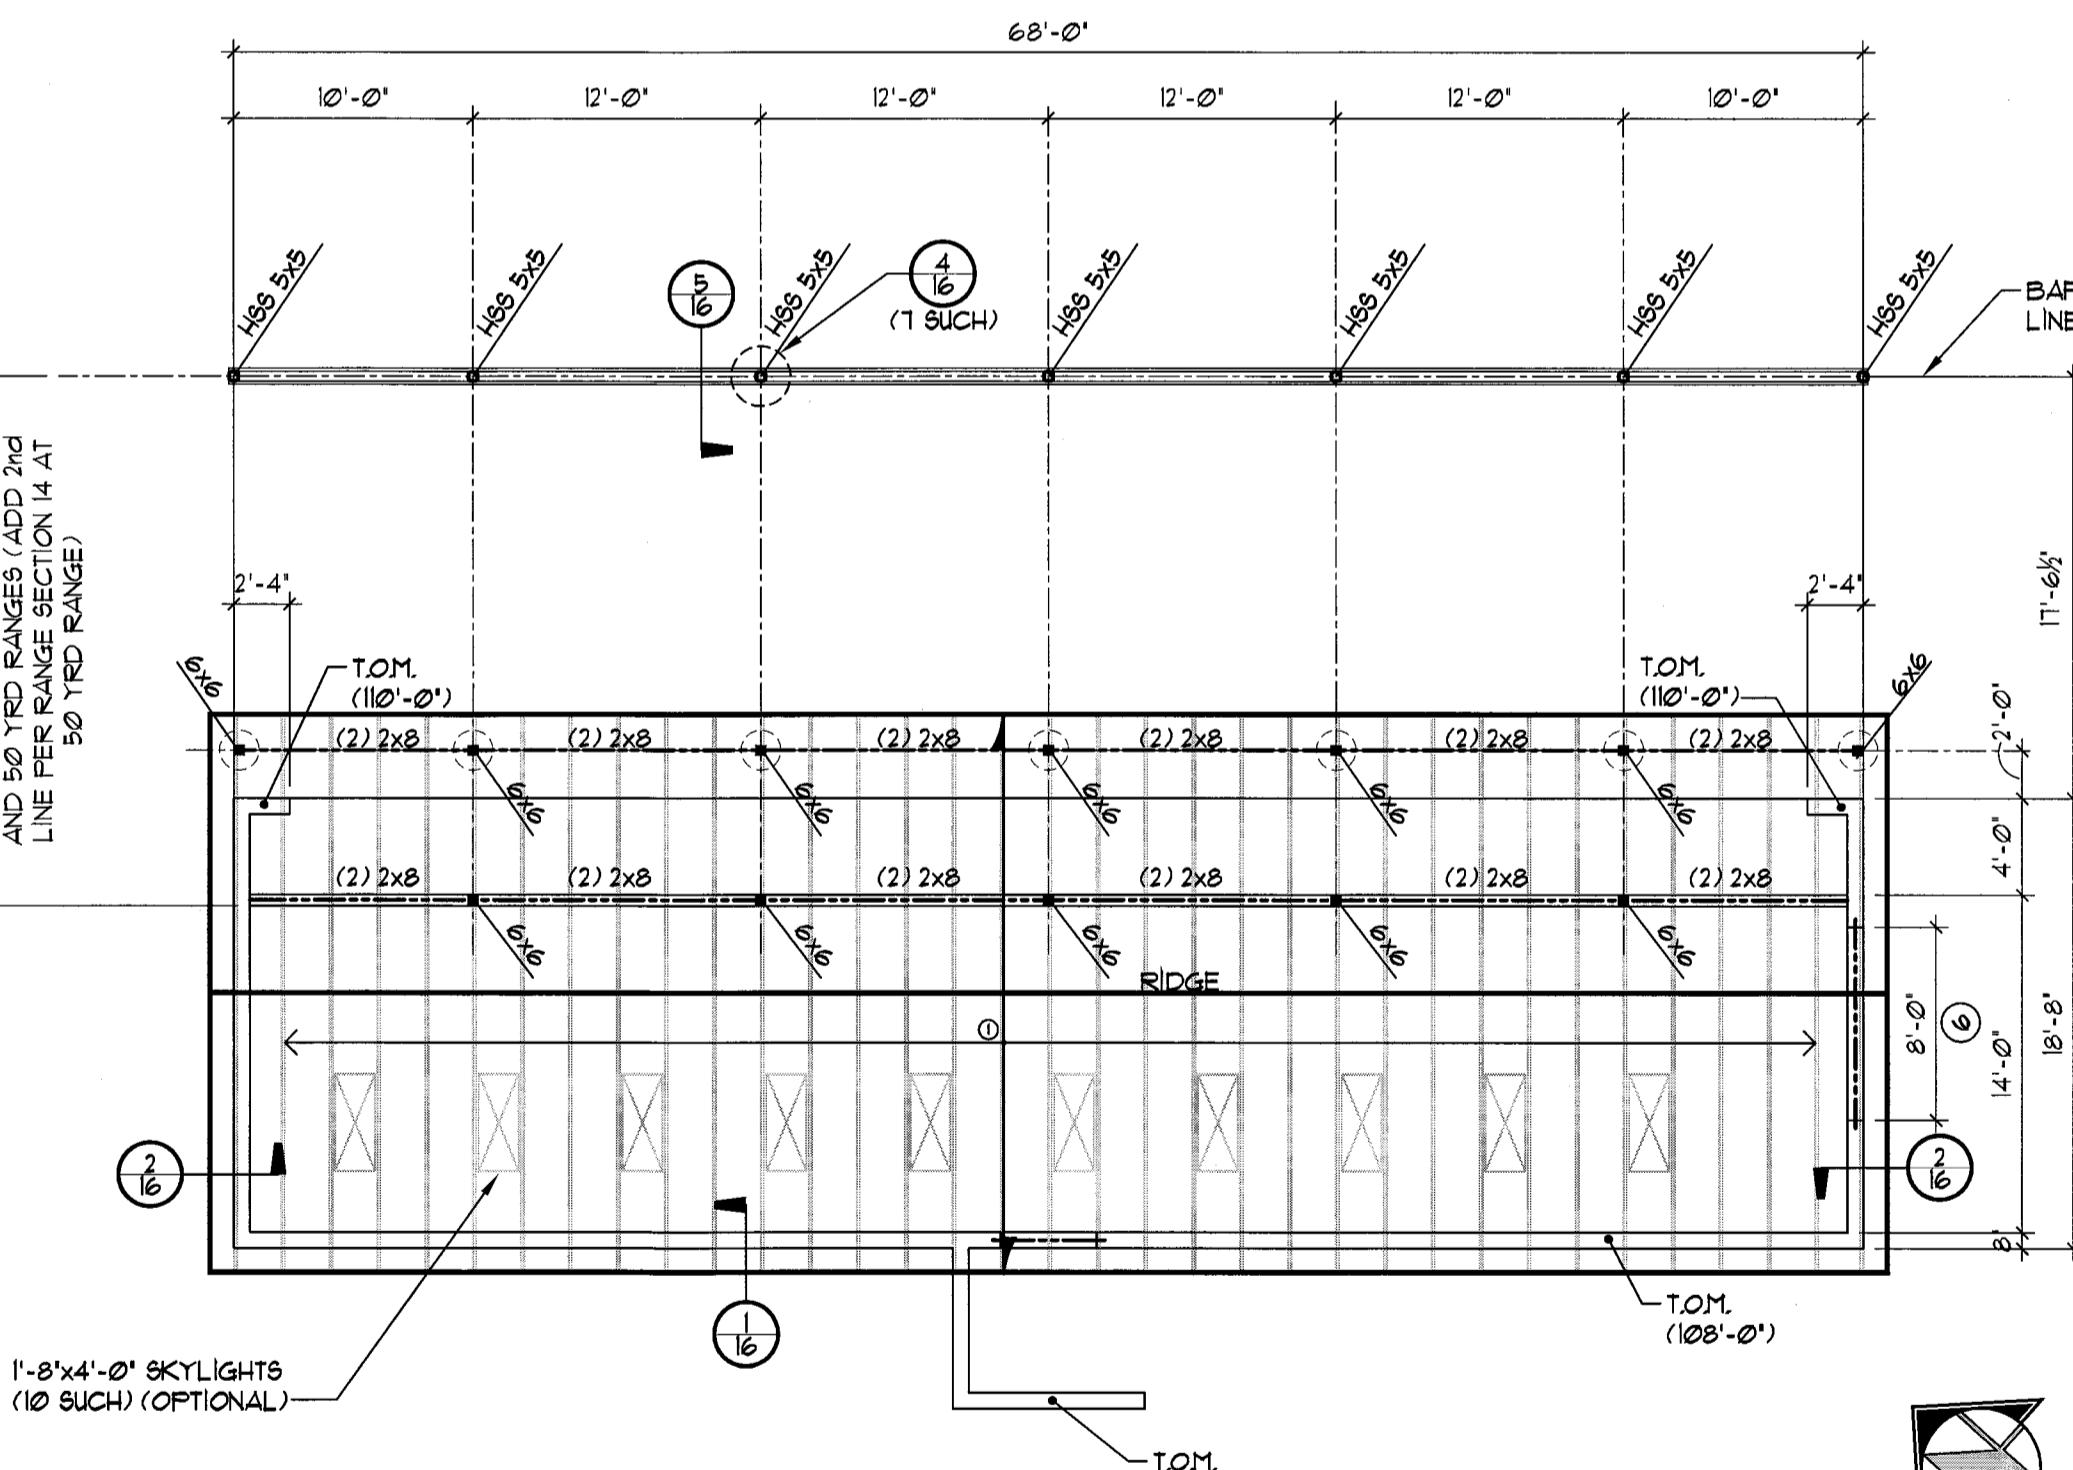


**10 STATION FIRING LINE STRUCTURE ROOF FRAMING PLAN**


SCALE: 1/8" = 1'-0"

**ROOF FRAMING PLAN NOTES**

1. PRE-ENGINEERED TRUSSES @ 24" O.C.
2. ROOF DECK IS 5/8" CDX PLYWOOD W/ 8D NAILS @ 6" O.C. ALONG SUPPORTED EDGES AND 12" O.C. IN FIELD
3. EXTERIOR WALLS ARE LIGHTWEIGHT CMU BEARING WALLS. REFER TO FOUNDATION DETAILS FOR REINFORCING FOR MASONRY CONTROL JOINTS RE: 6/16
4. ELEVATION TO OF CMU WALLS NOTED THIS: T.O.M. (X'-XX')
5. FOR LOOSE LINTEL SCHEDULE RE: 3/16
6. SIDE ENTRY ON ONE SIDE (ONLY) ADJACENT TO FUTURE BUILDING SITE

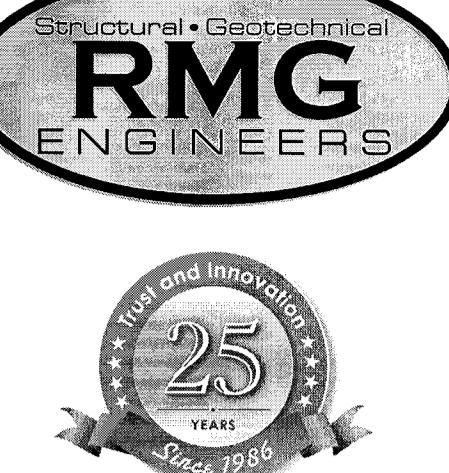

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## GOLD CAMP SHOOTING SPORTS CENTER

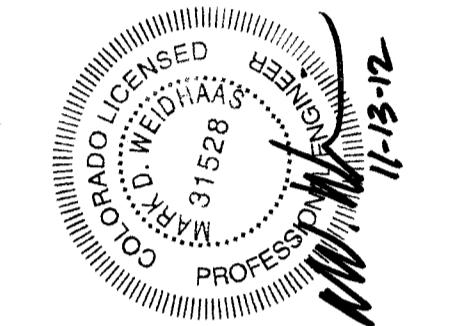CR 81  
TELLER COUNTY SHOOTING SOCIETY

CR 81

TELLER COUNTY, COLORADO

CR 81

TELLER COUNTY SHOOTING SOCIETY

ENGINEER: MW  
DRAWN BY: CL  
CHECKED BY: MW  
PRINTING: DATE:  
SUBMITTAL 11-05-12

REVISION: DATE:  
-

## GENERAL NOTES AND DETAILS

SHEET No. 15

OF 16  
JOB No. 131963

15

OF 16

### GENERAL STRUCTURAL NOTES

APPLICABLE CODES:  
A. These general notes apply to all structural drawings. This project is designed in accordance with the International Building Code (IBC) 2003 Edition, and the Minimum Design Loads for Buildings and Other Structures (ASCE 7-02) and the Teller County Building Code, 2002 changes.  
B. All material and workmanship shall be in accordance with applicable provisions of the codes specified above.

### 2 LOADS USED IN DESIGN

A. Roof Live Load: P (Balanced).....	40 psf
(And/or drift provisions ASCE 1-02, section 7.1)	
Snow Load Factor, C <sub>1</sub> .....	1.0
Snow Exposure Factor, C <sub>2</sub> .....	1.0
Roof Dead Load.....	10 psf
Floor Dead Load.....	60 psf
Wind Base Wind Speed, V <sub>0</sub> .....	80 mph
Wind Exposure.....	C'
Wind Importance Factor, I.....	1.0
Building Category:	
Internal Pressure Coefficient, C <sub>IP</sub> .....	1.025 psf

3. CONSTRUCTION:

A. **DO NOT SCALE**: Changes affecting the layout shown must be specific and clearly conveyed to RMG Engineers Group in written form as a formal change order. Construction drawings shall be checked against architectural drawings and any discrepancies shall be brought to the attention of the Architect and Engineer immediately. Refer to mechanical, electrical and architectural drawings for openings not shown on structural drawings.

B. Shop drawings shall be prepared by the fabricator. Copying of these construction documents for use as shop drawings will not be permitted. General contractor shall review shop drawings prior to submittal to the engineer.

C. General contractor shall be responsible for all site work.

D. Design is valid after two years from original date of issue, unless updated to acceptable codes and practices at that time.

E. A preconstruction meeting with personnel of RMG Engineers Group, the architect, contractor and appropriate subcontractors is strongly recommended prior to construction to discuss structural plans.

### 4 CONCRETE:

A. Concrete has been designed and shall be constructed in accordance with the American Concrete Institute Building Code Requirements, Reinforced Concrete, and "Specifications for Structural Concrete for Buildings" (ACI 318 and ACI 301) latest editions. Section 13 "Inspection" of ACI 318 is deleted in its entirety, see "Field Observations" paragraph. All concrete shall be of stone aggregate, unless noted otherwise.

B. See specifications for any additional durability requirements.

<sup>1/2" min. dia.</sup> 4000 psi minimum compressive strength at age of 28 days.

  1000 cu. yds. maximum, minimum of 540 pounds per cubic yard.

  Fly ash not allowed.

  3/4" maximum aggregate size.

  40 psi maximum slurry.

  Water reducing agent.

  Use in accordance with manufacturer's recommendations.

<sup>1/2" dia.</sup> For footings, grade beams, and miscellaneous concrete:

  3000 psi minimum compressive strength at age of 28 days.

  1000 cu. yds. maximum, minimum of 410 pounds per cubic yard.

  3/4" maximum aggregate size.

  40 psi maximum slurry.

  Water reducing agent.

  Use in accordance with manufacturer's recommendations.

<sup>1/2" dia.</sup> For footings, grade beams, and miscellaneous concrete:

  3000 psi minimum compressive strength at age of 28 days.

  1000 cu. yds. maximum, minimum of 410 pounds per cubic yard.

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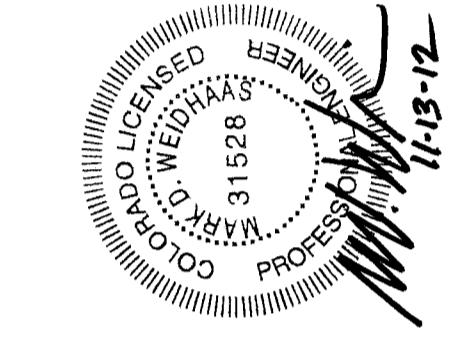
  1000 cu. yds. maximum, minimum of 410 pounds per cubic yard.

  Fly ash not allowed.

  3/4" maximum aggregate size.



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## GOLD CAMP SHOOTING SPORTS CENTER

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TELLER COUNTY, COLORADO  
TELLER COUNTY SHOOTING SOCIETY


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SUBMITTAL 11-05-12

REVISION: DATE:  
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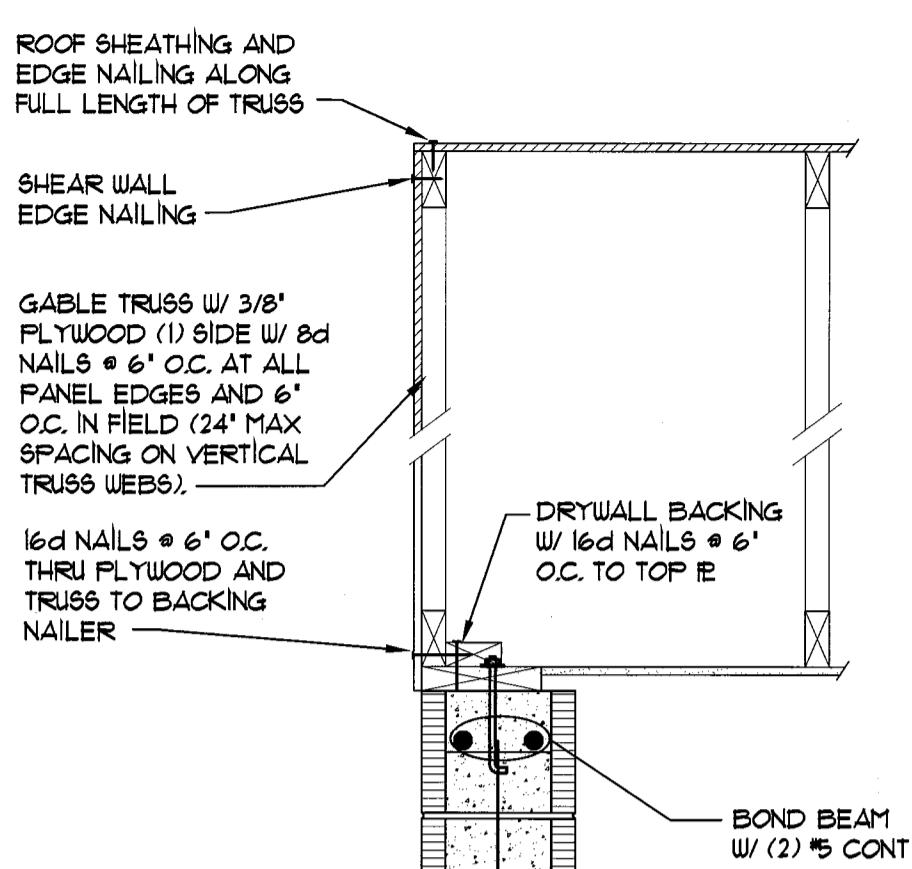
### FRAMING DETAILS

SHEET No.

**16** OF 16  
JOB No. 131963

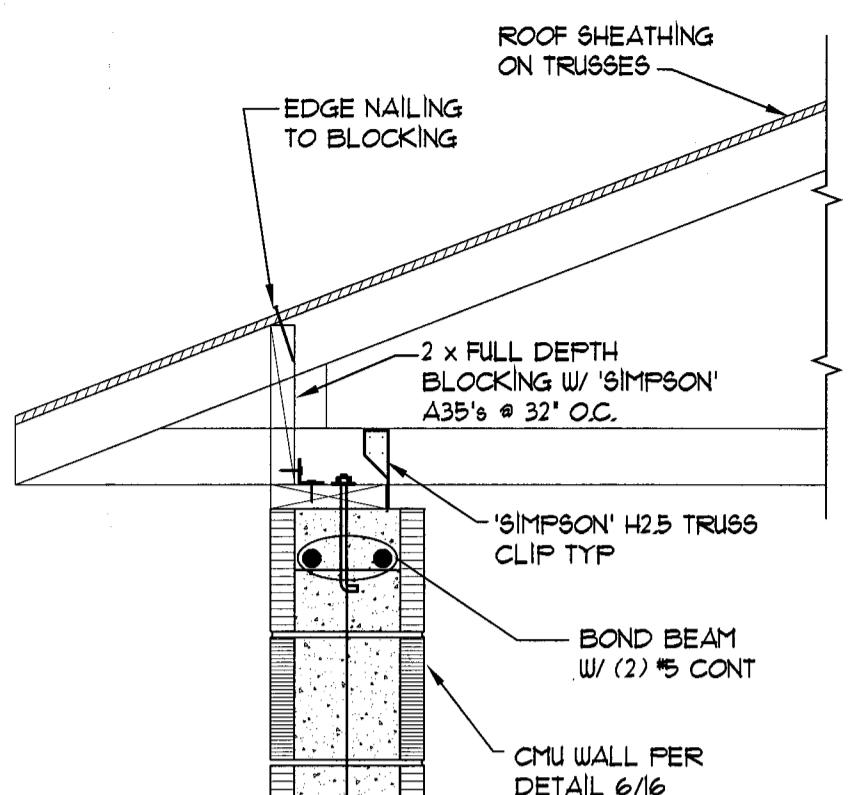

1  
16  
ROOF FRAMING DETAIL  
SCALE: 1' - 1'-0"




2  
16  
ROOF FRAMING DETAIL  
SCALE: 1' - 1'-0"


LOOSE LINTEL SCHEDULE AT EXISTING BUILDING		
SPAN	LINTEL SIZE	BRG
0' to 1'-4"	1/4" PLATE	4'
1'-4" to 3'-6"	L3/4" x 3" x 1/4" (LLV)	4'
3'-6" to 4'-6"	L3/4" x 3 1/2" x 1/4" (LLV)	6'
4'-6" to 5'-6"	L4 x 3 1/2" x 1/4" (LLV)	6'
5'-6" to 7'-0"	L5 x 3 1/2" x 1/4" (LLV)	6'
7'-0" to 8'-6"	L6 x 3 1/2" x 1/4" (LLV)	8'
8'-6" to 11'-0"	L7 x 4" x 3 1/2" (LLV)	8'

NOTES:  
1. 1/4" ANGLE FOR EACH 4' WYTHE OF MASONRY  
2. REFER TO ARCHITECTURAL & MECHANICAL DRAWINGS FOR LOCATION & SIZE OF OPENINGS  
3. BEARING DISTANCES SHOWN ABOVE ARE REQUIRED MINIMUMS AT EACH END OF LINTEL  
4. LINTEL SCHEDULE UNLESS NOTED OTHERWISE ON PLANS  
5. GENERAL CONTRACTOR TO COORDINATE HEAD HEIGHTS AND  
INSTALLATION OF LOOSE LINTELS WITH ARCHITECTURAL, DECO PLANS AND  
EXISTING CONDITIONS. STRUCTURAL FRAMING STRUCTURE ABOVE IS TO  
REACH AT LEAST 1/4" INTEL SPAN (OR MORE DEPENDING THE NEW LINTEL IF  
FIELD VERIFIED TO BE LESS, OR IF MIN. INTEL BEARING CANNOT BE  
ACHIEVED CONTACT RMG ENGINEERS GROUP TO DETERMINE IF  
ADDITIONAL STRUCTURAL SUPPORT IS REQUIRED


3  
16  
LOOSE LINTEL SCHEDULE  
SCALE: 1' - 1'-0"

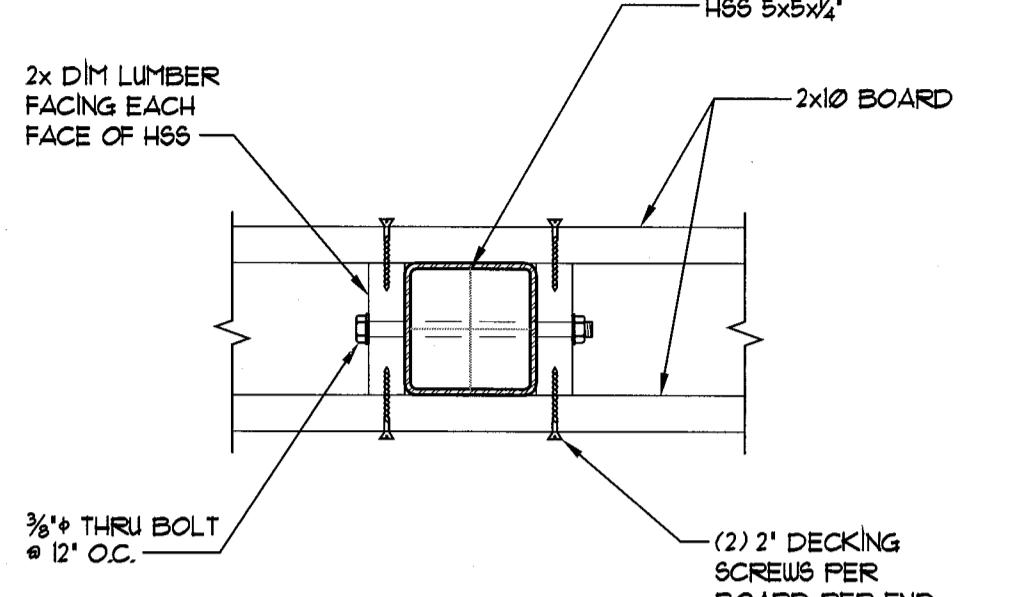


4  
16  
BAFFLE DETAIL  
SCALE: 1 1/2' - 1'-0"

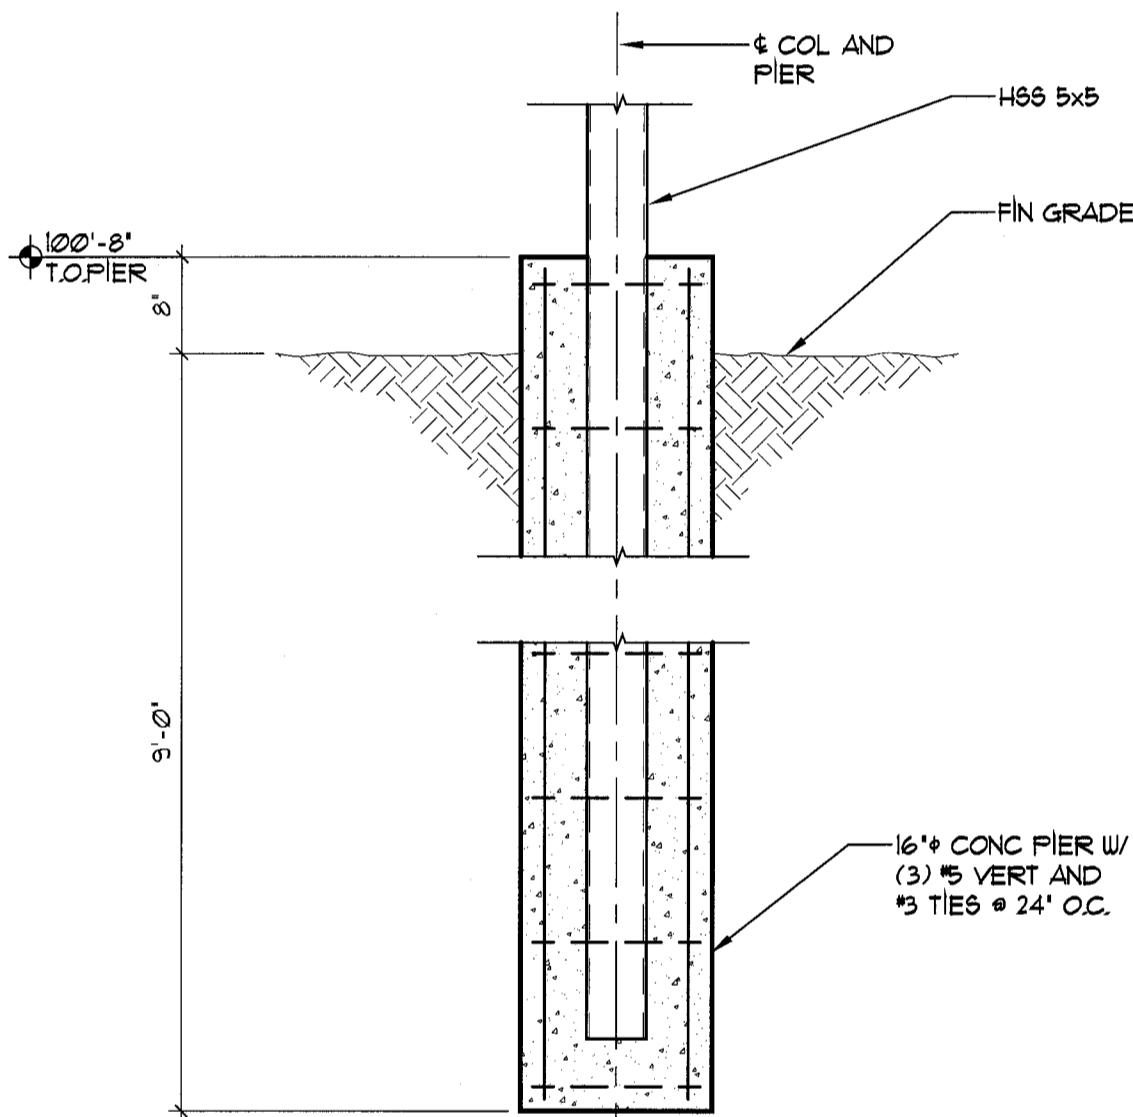


5  
16  
BAFFLE POLE FOUNDATION DETAIL  
SCALE: 3/4' - 1'-0"

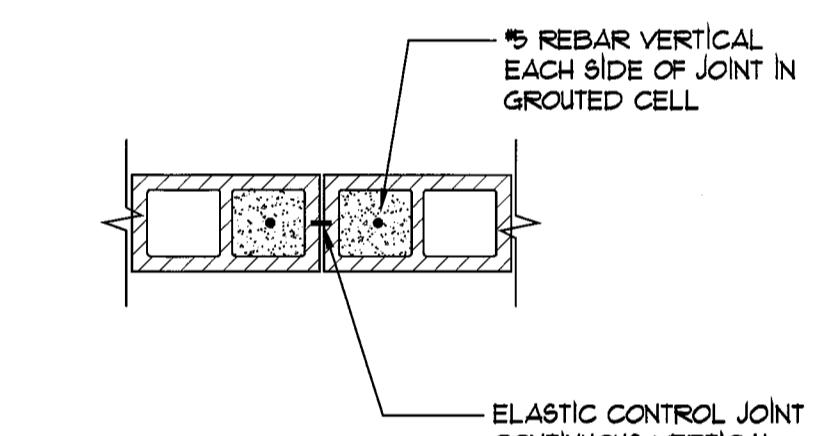

6  
16  
TYP. MASONRY CONTROL JOINT  
SCALE: 3/4' - 1'-0"

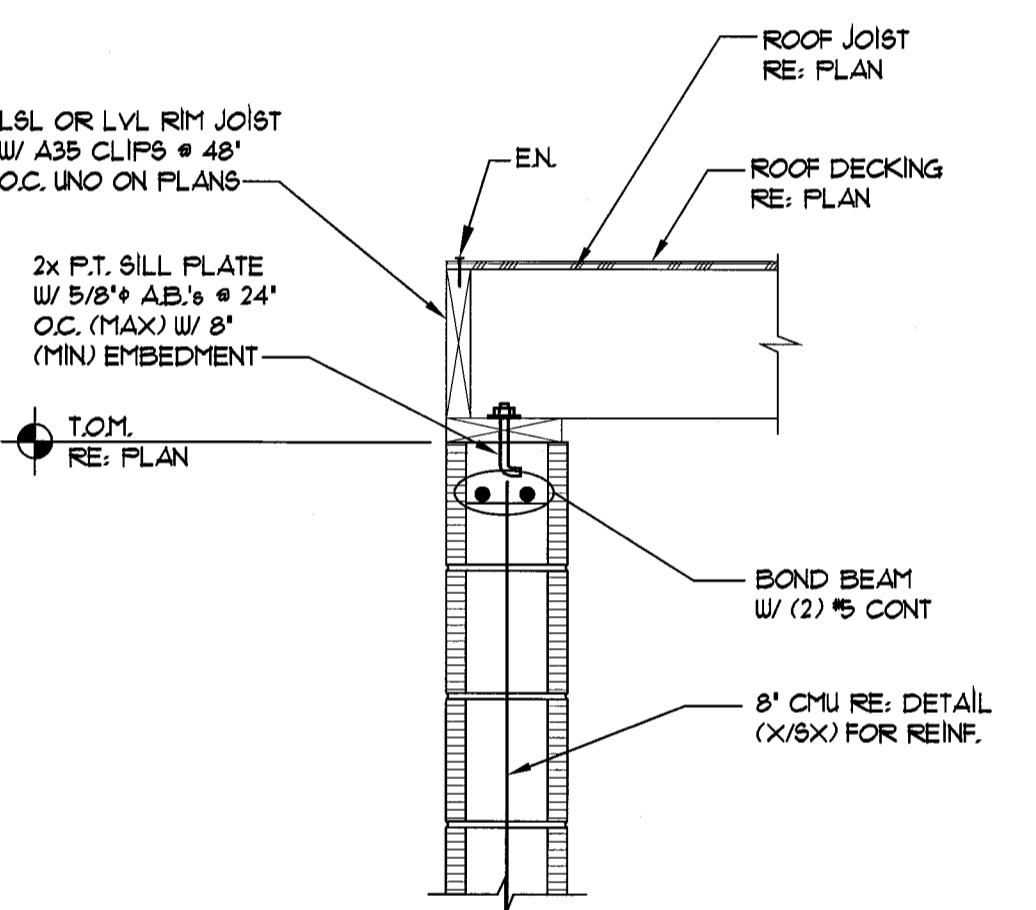

7  
16  
ROOF FRAMING DETAIL  
SCALE: 1' - 1'-0"

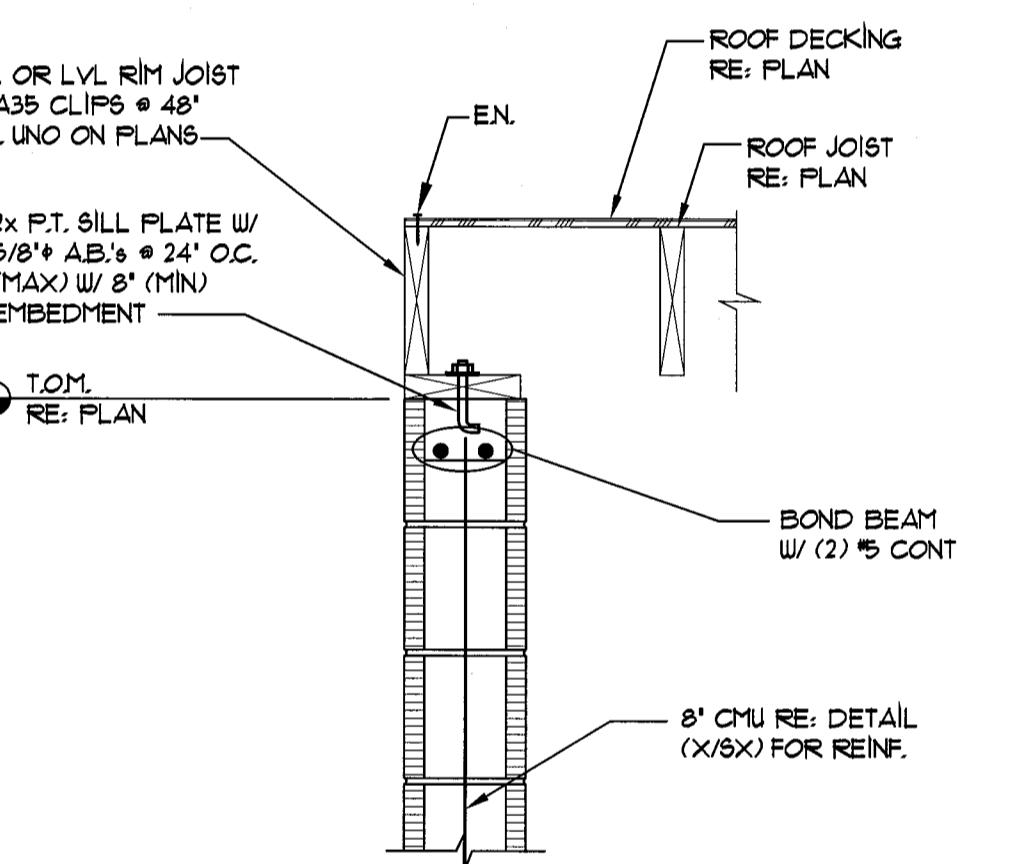

8  
16  
ROOF FRAMING DETAIL  
SCALE: 1' - 1'-0"